

# ATHI WATER WORKS DEVELOPMENT AGENCY(AWWDA)

# MINISTRY OF WATER, SANITATION AND IRRIGATION (MWSI)



In partnership with



### **BIDDING DOCUMENTS**

for

**Procurement of** 

### CONSTRUCTION WORKS FOR GIGIRI-KARURA-OUTERING ROAD TRANSMISSION PIPELINE PROJECT

# **VOLUME III: BOOK OF DRAWINGS**

IPC No: AWWDA/AFD/NWSP/W-02B/2023

Project: CKE1135-NAIROBI WATER AND SANITATION PROJECT

**Employer:** ATHI WATER WORKS DEVELOPMENT AGENCY

**Country:** KENYA

**Issued on:** 27<sup>th</sup> February 2024





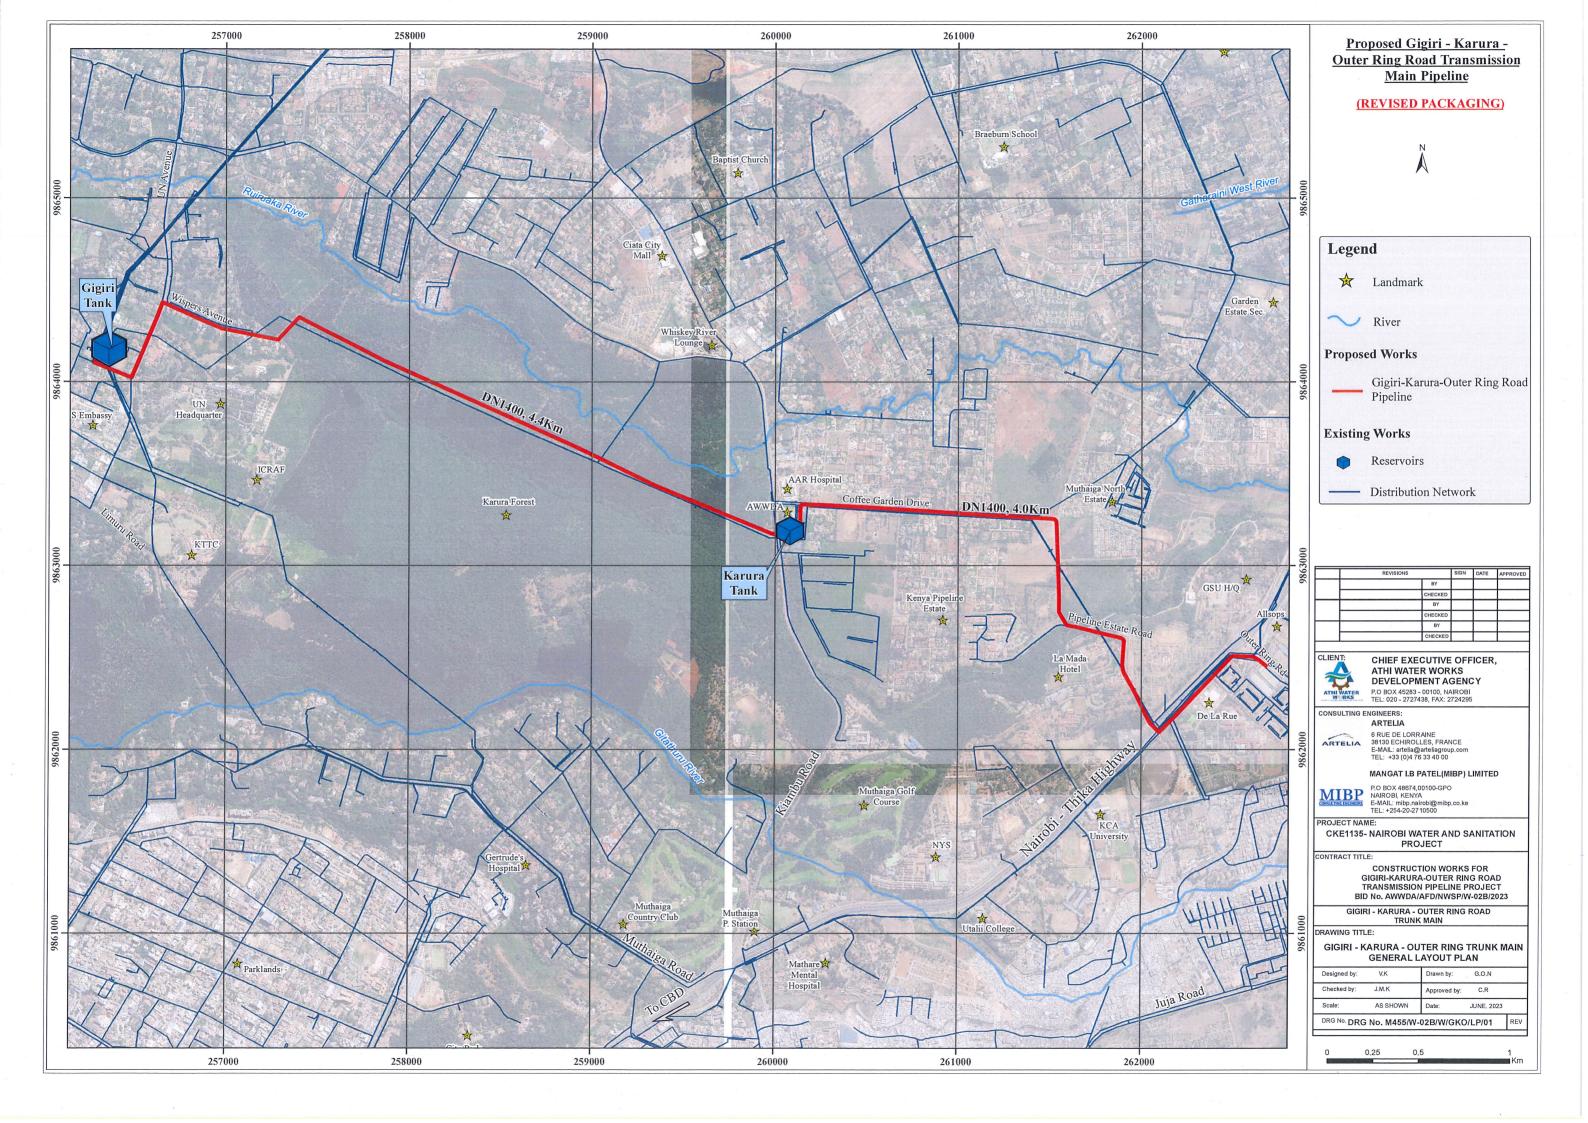
### CKE1135- NAIROBI WATER AND SANITATION PROJECT

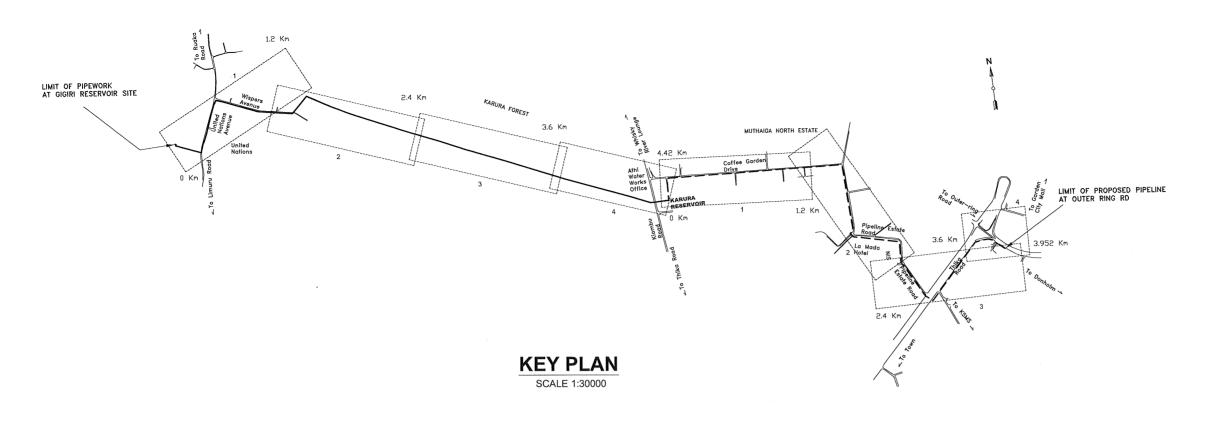
### CONSTRUCTION WORKS FOR GIGIRI - KARURA - OUTER RING ROAD TRANSMISSION PIPELINE PROJECT

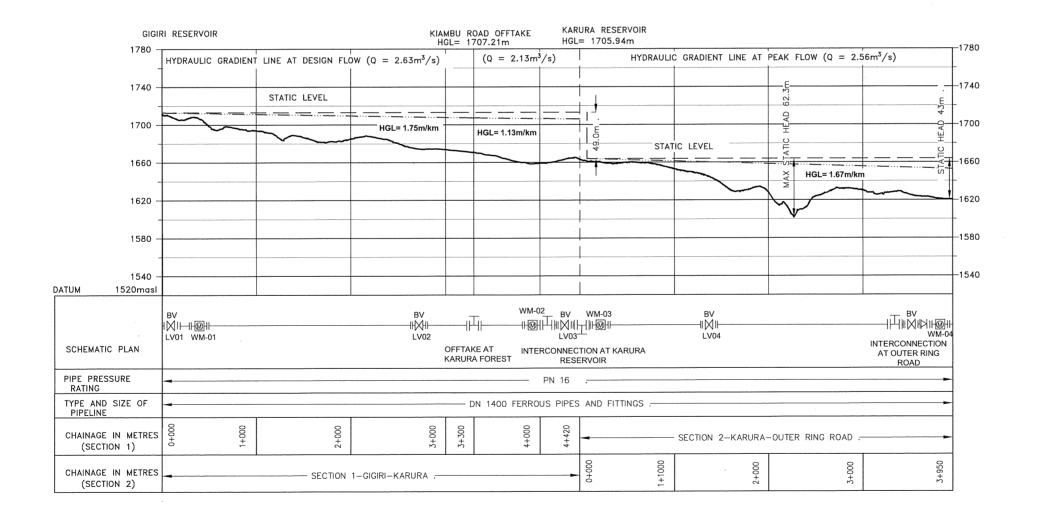
### BID No. AWWDA/AFD/NWSP/W-02B/2023

### SCHEDULE OF ENGINEERING DRAWINGS

DRG NO.	<u>DESCRIPTION</u>
	GIGIRI - KARURA PIPELINE SECTION (LINE GK)
M455/W-02B/W/GKO/LP/01	LAYOUT PLAN
M455/W-02B/W/GKO/G/LP/01	GIGIRI - KARURA - OUTER - RING TRUNK MAIN - KEY PLAN AND HYDRAULIC PROFILE
M455/W-02B/W/GK/01	
	GIGIRI - KARURA - PIPELINE SECTION (LINE GK) - PLAN AND LONGITUDINAL SECTION - SHEET 1 OF 5 - CH 0+000 - CH 1+200
M455/W-02B/W/GK/02	GIGIRI - KARURA - PIPELINE SECTION (LINE GK) - PLAN AND LONGITUDINAL SECTION - SHEET 2 OF 5 - CH 1+200 - CH 2+400
M455/W-02B/W/GK/03	GIGIRI - KARURA - PIPELINE SECTION (LINE GK) - PLAN AND LONGITUDINAL SECTION - SHEET 3 OF 6 - CH 2+400 - CH 3+600
M455/W-02B/W/GK/04	GIGIRI - KARURA - PIPELINE SECTION (LINE GK) - PLAN AND LONGITUDINAL SECTION - SHEET 4 OF 6 - CH 3+600 - CH 4+420
M455/W-02B/W/GK/05	GIGIRI - KARURA - PIPELINE SECTION (LINE GK) -) PLAN AND LONGITUDINAL SECTION - SHEET 5 OF 6 - FITTINGS DETAILS
M455/W-02B/W/GK/06	GIGIRI - KARURA - PIPELINE SECTION (LINE GK) -) PLAN AND LONGITUDINAL SECTION - SHEET 6 OF 6 - INTAKE VALVE CHAMBER FITTINGS DETAILS
	KARURA - OUTER RING ROAD PIPELINE SECTION (LINE KO)
M455/W-02B/W/K0/01	KARURA - OUTER RING ROAD PIPELINE SECTION (LINE KO) PLAN AND LONGITUDINAL SECTION - SHEET 1 OF 4 - CH 0+000 - CH 1+200
M455/W-02B/W/K0/02	KARURA - OUTER RING ROAD PIPELINE SECTION (LINE KO) PLAN AND LONGITUDINAL SECTION - SHEET 2 OF 4 - CH 1+200 - CH 2+400
M455/W-02B/W/K0/03	KARURA - OUTER RING ROAD PIPELINE SECTION (LINE KO) PLAN AND LONGITUDINAL SECTION - SHEET 3 OF 4 - CH 2+400 - CH 3+600
M455/W-02B/W/K0/04	KARURA - OUTER RING ROAD PIPELINE SECTION (LINE KO) PLAN AND LONGITUDINAL SECTION - SHEET 4 OF 4 - CH 3+950
	STANDARD DRAWINGS
M455/W-02B/SD/01	STANDARD DETAILS - PROJECT SIGN BOARD DETAIL
M455/W-02B/SD/02	STANDARD DETAILS - AIR VALVE CHAMBERS AND FITTINGS
M455/W-02B/SD/03	STANDARD DETAILS - WASHOUT OUTFALL STRUCTURE AND FIRE HYDRANT DETAILS (SHEET 1 OF 2)
M455/W-02B/SD/04	STANDARD DETAILS - WASHOUT OUTFALL STRUCTURE AND FIRE HYDRANT DETAILS (SHEET 2 OF 2)
M455/W-02B/SD/05	STANDARD DETAILS - INLINE/OFFTAKE VALVE CHAMBER, FITTINGS AND ACCESS LADDER SHEET 1 OF 2
M455/W-02B/SD/06	STANDARD DETAILS - INLINE/OFFTAKE VALVE CHAMBER, FITTINGS AND ACCESS LADDER SHEET 2 OF 2
M455/W-02B/SD/07	STANDARD DETAILS - METER CHAMBER FITTINGS AND DETAILS
M455/W-02B/SD/08	STANDARD DETAILS - CHAMBER COVERS
-1	
M455/W-02B/SD/09	STANDARD DETAILS - THRUST BLOCKS SHEET
M455/W-02B/SD/10	STANDARD DETAILS - ANCHOR BLOCKS AND INDICATOR POSTS
M455/W-02B/SD/11	STANDARD DETAILS - PIPE TRENCH AND CONCRETE SORROUND
M455/W-02B/SD/12	STANDARD DETAILS - TRENCHLESS ROAD CROSSING
M455/W-02B/SD/13	STANDARD DETAILS - PERMANENT REINSTATEMENT OF PAVEMENTS
M455/W-02B/SD/14	STANDARD DETAILS - PIERS AND PIER SUPPORTS
M455/W-02B/SD/15	STANDARD DETAILS - DETAILS OF CHECKERED PLATE COVERS FOR CHAMBERS SHEET 1 OF 2
M455/W-02B/SD/16	STANDARD DETAILS OF CHECKERED PLATE COVERS FOR CHAMBERS SHEET 2 OF 2
M455/W-02B/SD/17	STANDARD DETAILS - DETAILS OF STORMWATER CATCH PIT AND EARTH DRAINS
M455/W-02B/SD/19	STANDARD DETAILS - TYPICAL ROAD CROSS SECTION DETAILS
M455/W-02B/SD/19	STANDARD DETAILS - INVERT BLOCK DRAINS AND HEADWALL DETAILS
*	







### **HYDRAULIC PROFILE**

H- 1:40000, V- 1:4000

# NOTES: LEGEND: PROPOSED WATER MAIN (SECTION 1 PROPOSED WATER MAIN (SECTION 2) STATIC PRESSURE LINE HYDRAULIC GRADIENT LINE SHEET & SHEET NUMBER $[\bigvee_{LV}^{BV}] \ \ \frac{BV}{LV}$ BUTTERFLY VALVE ₩W WM WATER METER (with Ref. No.) $\bowtie$ CHECK VALVE (NON RETURN VALVE) METRES ABOVE SEA LEVEL

### CLIENT:

THE CHIEF EXECUTIVE OFFICER

ATHI WATER WORKS DEVELOPMENT
AGENCY

P.O BOX 45283 - 00100 NAIROBI TEL: 020 - 2727438 FAX: 2724295

CONSULTING ENGINEERS: JOINT VENTURE

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MIBP MANGAT I.B PATEL (MIBP) LIMITED P.O BOX 48674,00100-GPO,

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E-MAIL: mibp.nairobi@mibp.co.ke
TEL: +254-2-2710500

PROJECT NAME:

CKE1135- NAIROBI WATER AND SANITATION PROJECT

CONTRACT TITLE:

CONSTRUCTION WORKS FOR GIGIRI-KARURA-OUTER RING ROAD TRANSMISSION PIPELINE AND NORTH NAIROBI WATER AND SEWERAGE PROJECT BID NO. AWWDA/AFD/NWSP/W-02B/2023

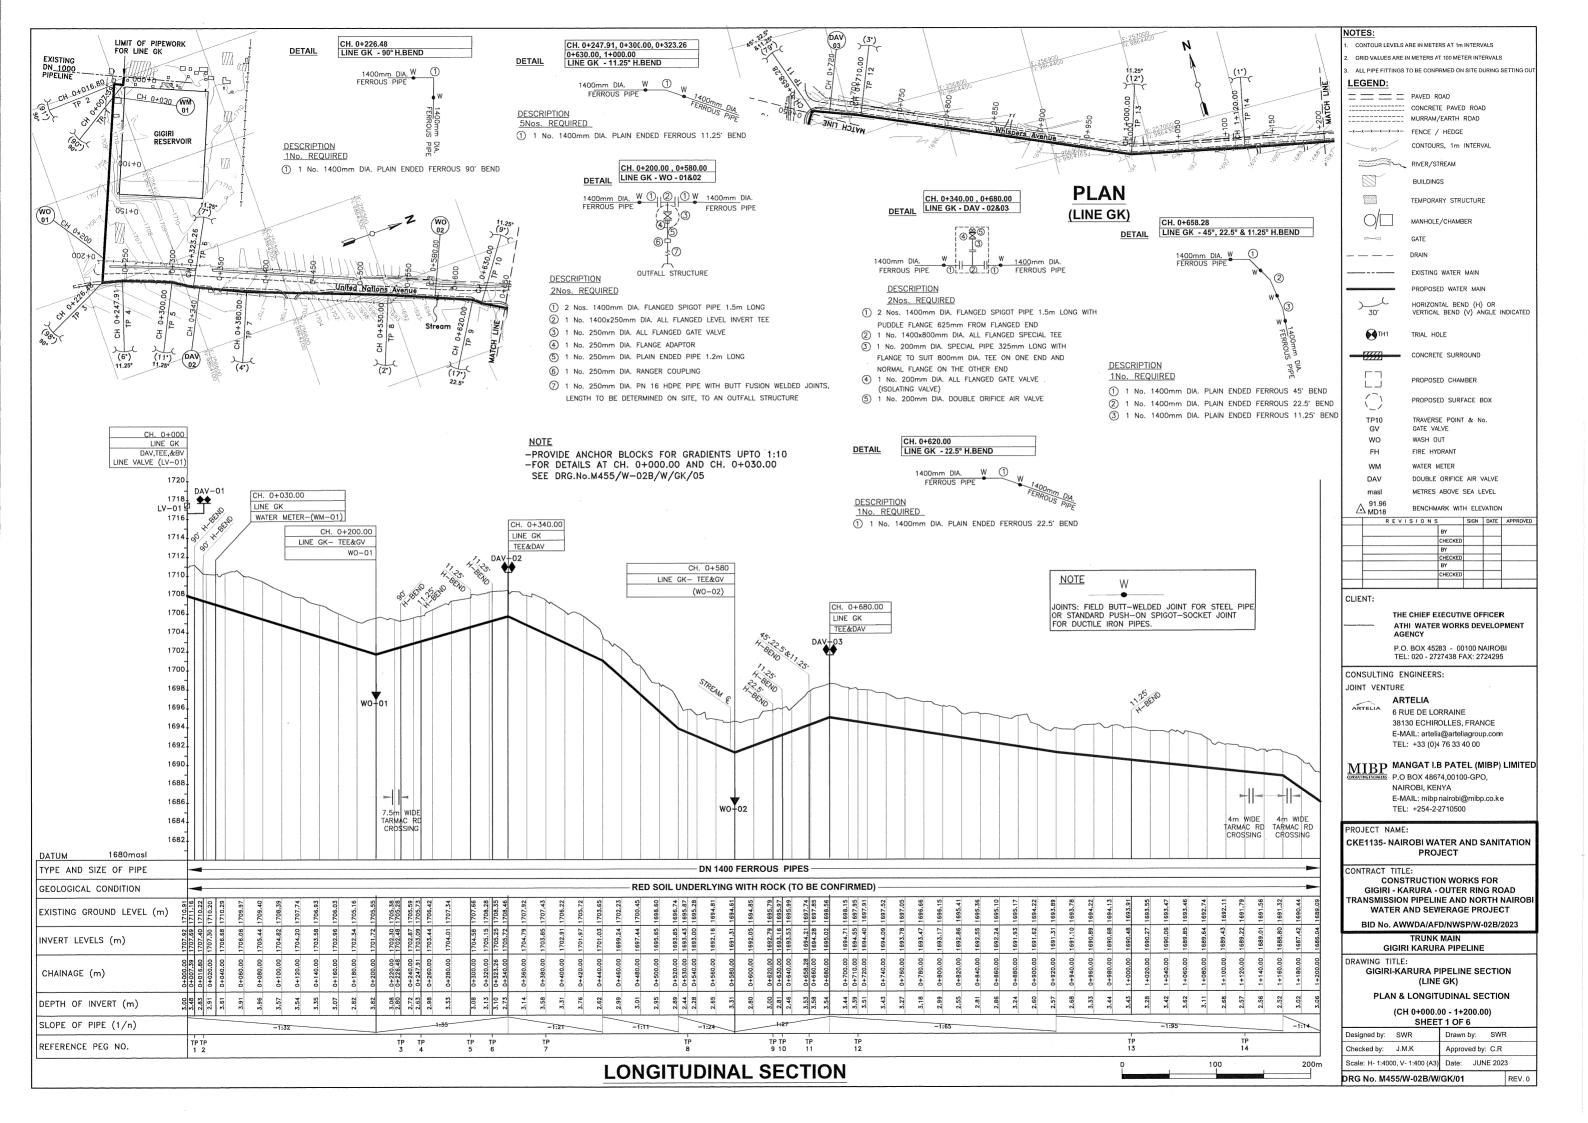
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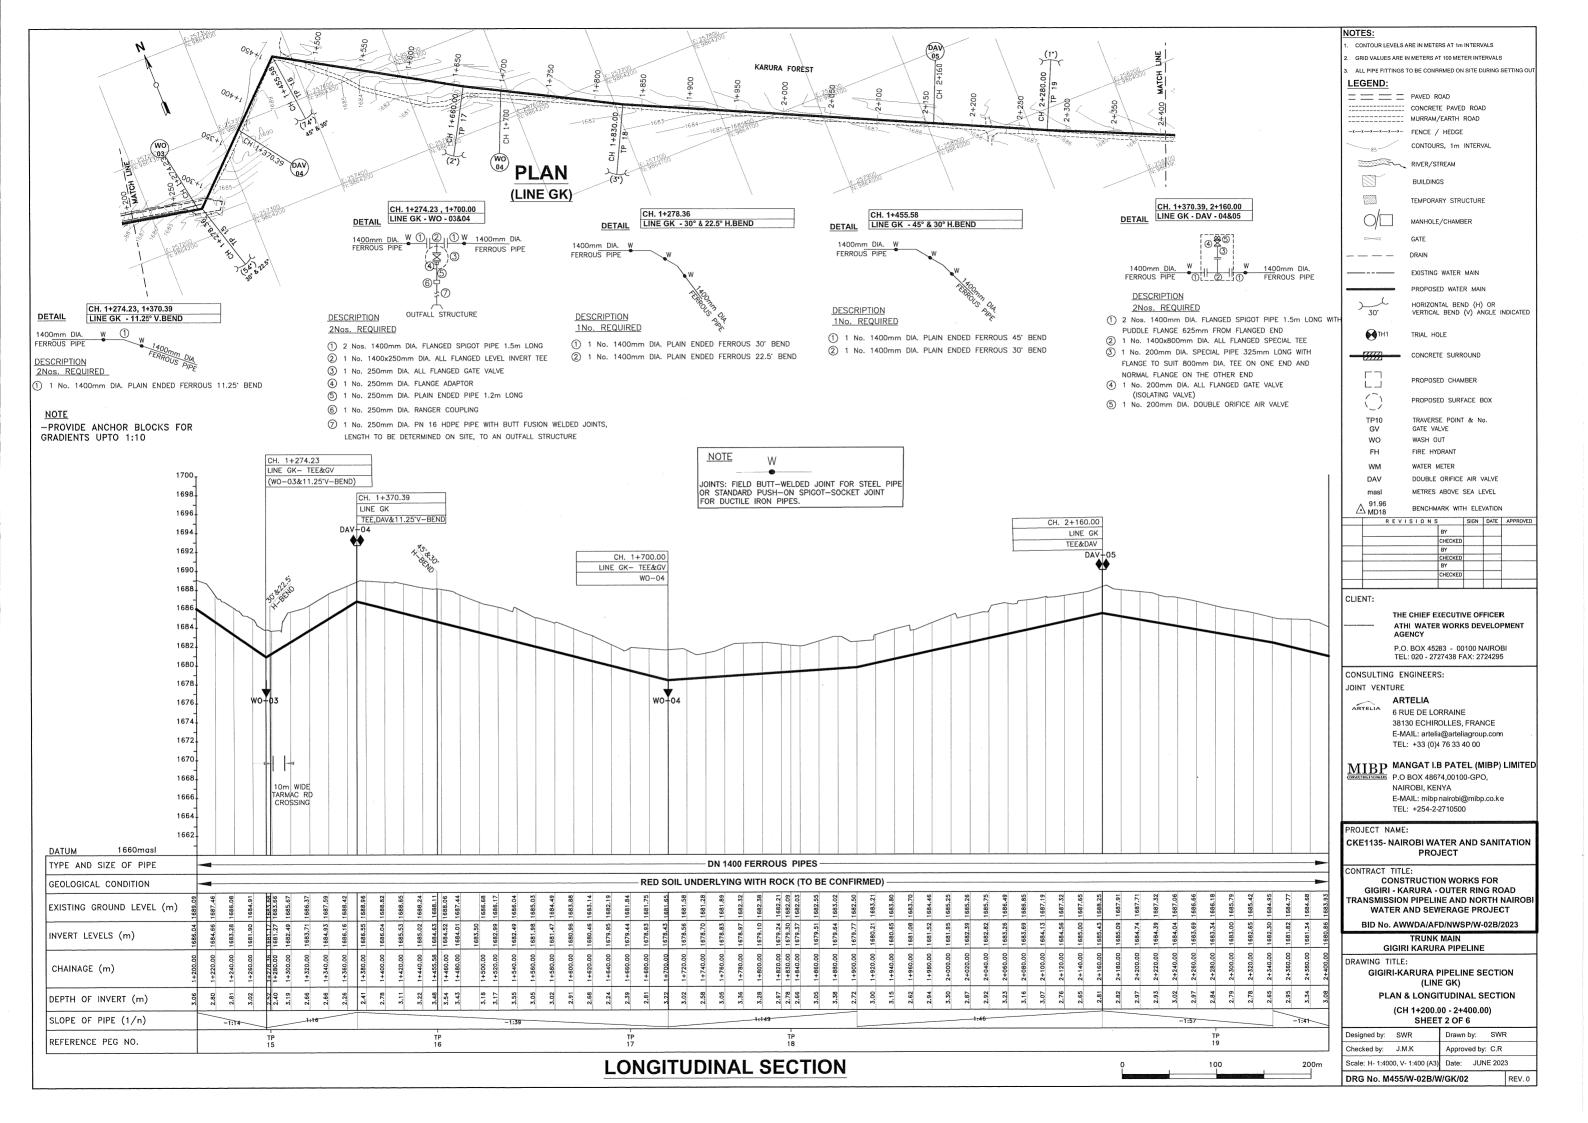
GIGIRI KARURA OUTER RING TRUNK MAIN


### KEY PLAN AND HYDRAULIC PROFILE


Designed by: S.W.R	Drawn by: F.I	M.M
Checked by: J.M.K	Approved by: C.	3
Scale: AS SHOWN	Date: JUNE 20	)23
Drg No. M455/W-02B/W/G	KO/G/LP/01	REV. 0
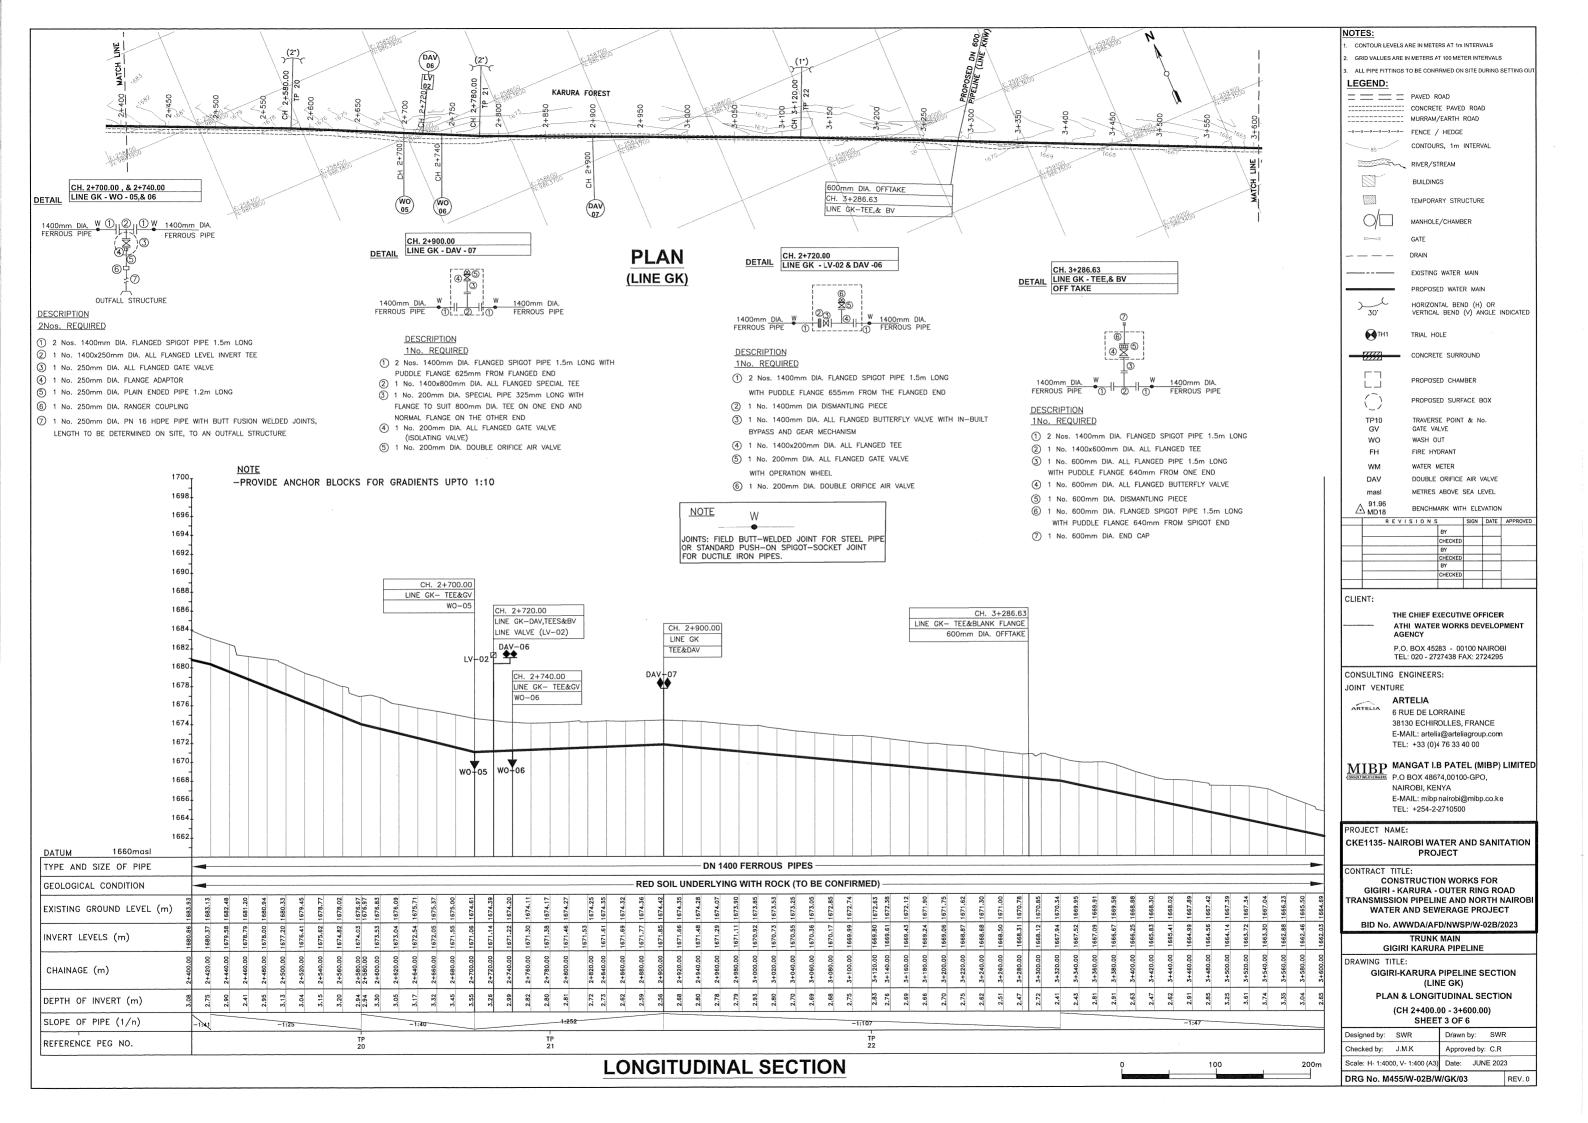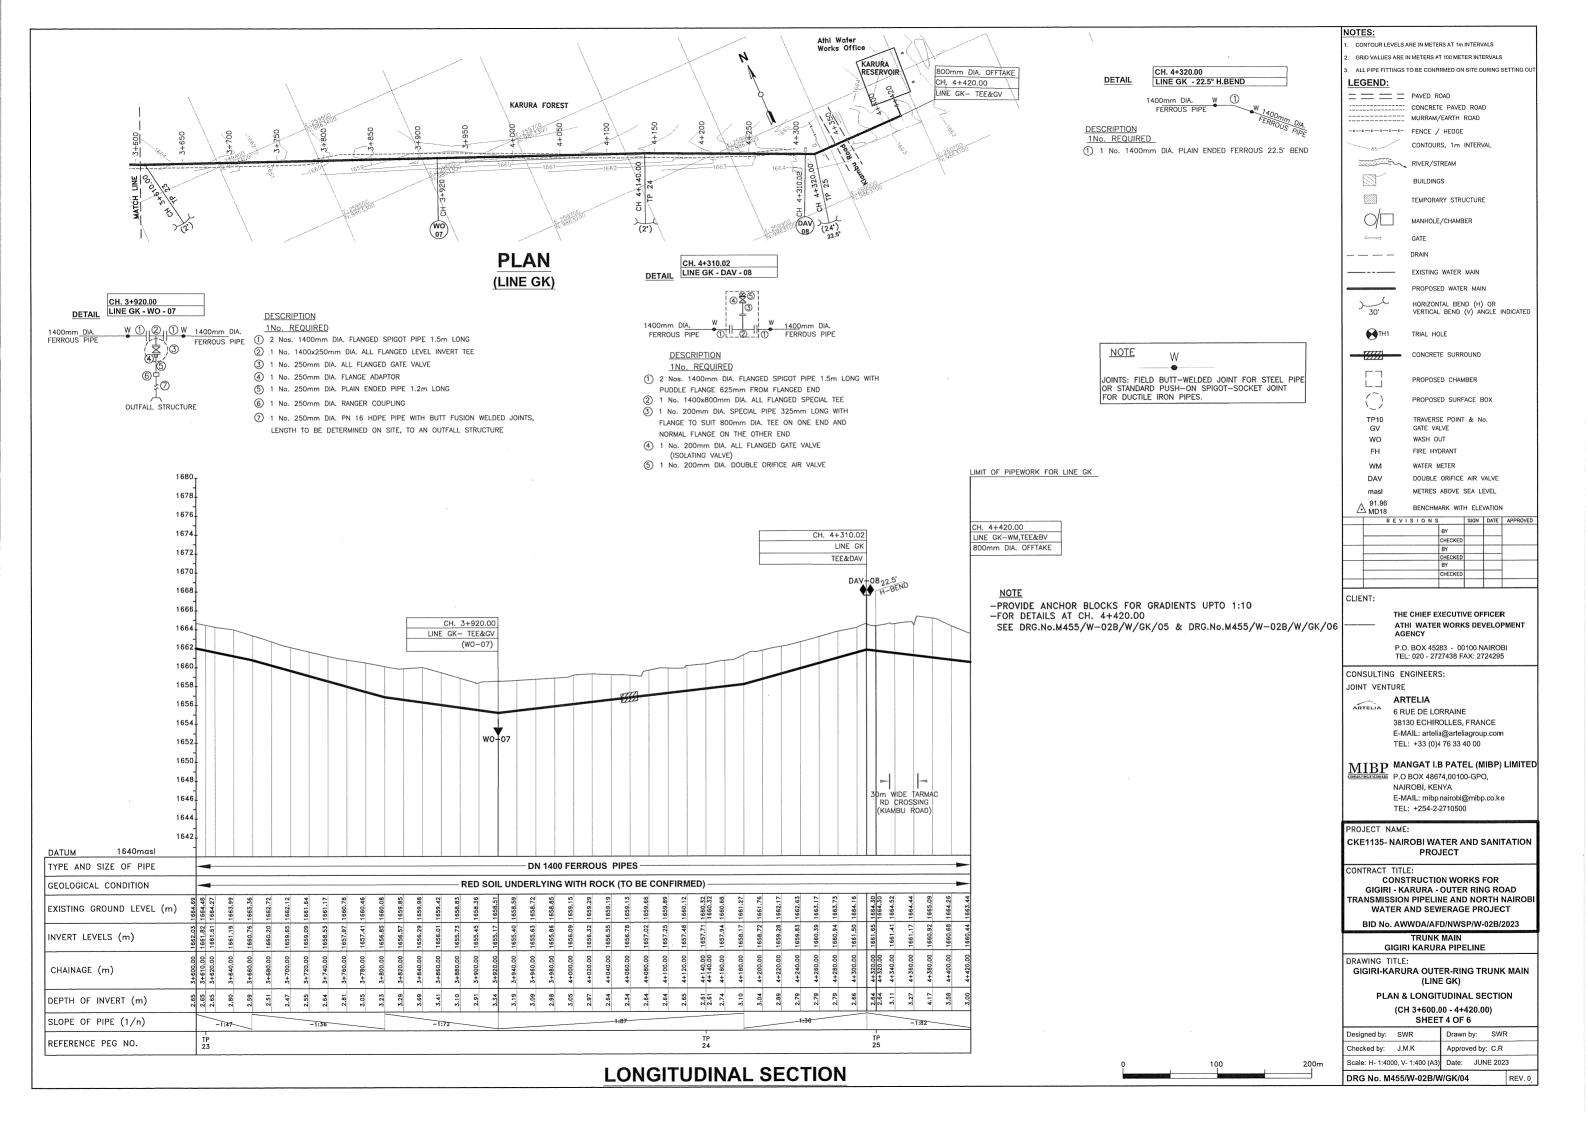
# GIGIRI - KARURA PIPELINE SECTION (LINE GK)









. <u>O</u>IL 2 1 CH. 0+030.00

CH 0+000


LINE GK - TEE, LV-01& DAV-01

### DESCRIPTION
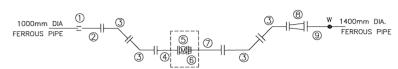
### 1No. REQUIRED

- 1 4 Nos. 1000mm DIA STRAIGHT COUPLING
- (2) 1 No. 1000x1000mm DIA, PLAIN ENDED TEE
- (3) 2 Nos. 1000mm DIA. FLANGED SPIGOT PIPE 6m LONG (CUT TO SUIT ON SITE)
- 4 2 Nos. 1000mm DIA. ALL FLANGED 90' BEND
- (5) 1 No. 1000mm DIA. FLANGE ADAPTOR
- (6) 1 No. 1000mm DIA. ALL FLANGED PIPE 1.5m LONG WITH PUDDLE FLANGE 655mm FROM ONE END
- (7) 1 No. 1000mm DIA, DISMANTLING PIECE
- (8) 1 No. 1000mm DIA. ALL FLANGED BUTTERFLY VALVE
- 9 1 No. 1000x200mm DIA. ALL FLANGED SPECIAL TEE
- (10) 1 No. 200mm DIA. ALL FLANGED GATE VALVE
- WITH OPERATION WHEEL
- 1 No. 200mm DIA. DOUBLE ORIFICE AIR VALVE
- 1 No. 1000mm DIA, FLANGED SPIGOT PIPE 1.5m LONG
- WITH PUDDLE FLANGE 655mm FROM FLANGED END 1 No. 1000mm PLAIN ENDED PIPE 15m LONG WITH COUPLINGS
- (CUT TO SUIT ON SITE)

CH 0+030 00 LINE GK - WM-01



### DESCRIPTION

### 1No. REQUIRED

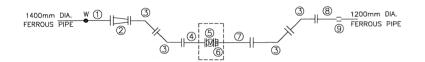
- 1 No. 1000mm DIA STRAIGHT COUPLING
- 2 1 No. 1000mm DIA, FLANGED SPIGOT PIPE 1.5m LONG (CUT TO SUIT ON SITE)
- 3 4 Nos. 1000mm DIA. ALL FLANGED 45' BEND
- WITH PUDDLE FLANGE AT 655mm FROM ONE END
- (5) 1 No. 1000mm DIA. ALL FLANGED ELECTROMAGNETIC WATER METER
- (6) 1 No. 1000mm DIA, DISMANTLING PIECE
- 7) 1 No. 1000mm DIA. ALL FLANGED PIPE 5m LONG WITH PUDDLE FLANGE AT 655mm FROM ONE END
- 8 1 No. 1400x1000mm DIA. ALL FLANGED CONCENTRIC TAPER
- (9) 1 No. 1400mm DIA, FLANGED SPIGOT PIPE 1.5m LONG (CUT TO SUIT ON SITE)

### PART FITTING DETAILS FOR DRG No. M455/W-03/W/GK/01

NOTE

JOINTS: FIELD BUTT-WELDED JOINT FOR STEEL PIPE OR STANDARD PUSH-ON SPIGOT-SOCKET JOINT

DETAIL CH. 4+420.00 LINE GK - TEE,BV&WM OFF TAKE




### DETAIL 1

### DESCRIPTION

### 1No. REQUIRED

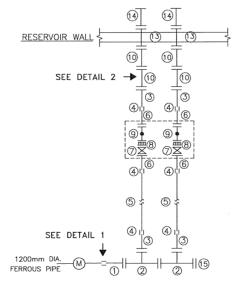- 1) 1 No. 1400mm DIA. FLANGED SPIGOT PIPE 1.5m LONG (CUT TO SUIT ON SITE)
- 2 1 No. 1400x1200mm DIA. ALL FLANGED CONCENTRIC TAPER
- 3 4 Nos. 1200mm DIA. ALL FLANGED 45' BEND
- (4) 1 No. 1200mm DIA. ALL FLANGED PIPE 12m LONG WITH PUDDLE FLANGE AT 645mm FROM ONE END
- (5) 1 No. 1200mm DIA. ALL FLANGED ELECTROMAGNETIC WATER METER
- 6 1 No. 1200mm DIA. DISMANTLING PIECE
- (7) 1 No. 1200mm DIA. ALL FLANGED PIPE 6m LONG
- WITH PUDDLE FLANGE AT 645mm FROM ONE END
- (8) 1 No. 1200mm DIA. FLANGED SPIGOT PIPE 1.5m LONG (CUT TO SUIT ON SITE)
- 9 1 No. 1200mm DIA STRAIGHT COUPLING




PART FITTING DETAILS FOR DRG No. M455/W-02B/W/GK/04

### DESCRIPTION
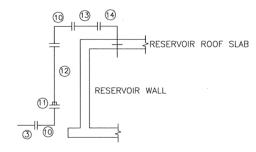
### 1 No. REQUIRED

- (1) 1 No. 1200mm DIA. FLANGED SPIGOT PIPE 1.5m LONG
- 2 Nos. 1200x800mm DIA. ALL FLANGED TEE
- 3 4 Nos. 800mm DIA. FLANGED SPIGOT PIPE 1.5m LONG (CUT TO SUIT ON SITE)
- 4 6 Nos. 800mm DIA STRAIGHT COUPLING
- (5) 2 Nos. 800mm PLAIN ENDED PIPE 15m LONG WITH COUPLINGS (CUT TO SUIT ON SITE)
- 6 4 Nos. 800mm DIA. FLANGED SPIGOT PIPE 1.5m LONG WITH PUDDLE FLANGE 880mm FROM FLANGED END
- (7) 2 Nos. 800mm DIA. ALL FLANGED BUTTERFLY VALVE
- 8 2 Nos. 800mm DIA. DISMANTLING PIECE
- 9 2 Nos. 800mm DIA. ALL FLANGED FLOW CONTROL VALVE WITH INBUILT ALTITUDE VALVE FUNCTION
- (10) 4 Nos. 800mm DIA. ALL FLANGED 90' BEND
- (1) 2 Nos. 800mm DIA. FLANGE ADAPTOR
- (12) 2 Nos. 800mm DIA. FLANGED SPIGOT PIPE 6m LONG (CUT TO SUIT ON SITE)
  - 2 Nos. 800mm DIA. ALL FLANGED PIPE 2m LONG
- 2 Nos. 800mm DIA. FLANGED SPIGOT 90' BEND WITH PUDDLE FLANGE 450mm FROM PLAIN END
- (5) 1 No. 1200mm DIA. BLANK FLANGE

-FOR INTAKE VALVE CHAMBER AND FITTINGS DETAILS AT CH. 4+420.00 SEE DRG.No.M455/W-02B/W/GK/06



DETAIL 2

CONTOUR LEVELS ARE IN METERS AT 1m INTERVALS GRID VALUES ARE IN METERS AT 100 METER INTERVALS ALL PIPE FITTINGS TO BE CONFIRMED ON SITE DURING SETTING O LEGEND: = = = = PAVED ROAD CONCRETE PAVED ROAD --- MURRAM/EARTH ROAD x-x-x-x-x- FENCE / HEDGE CONTOURS, 1m INTERVAL RIVER/STREAM 7 BUILDINGS TEMPORARY STRUCTURE MANHOLE/CHAMBER GATE EXISTING WATER MAIN HORIZONTAL BEND (H) OR VERTICAL BEND (V) ANGLE INDICATED TRIAL HOLE CONCRETE SURROUND PROPOSED CHAMBER PROPOSED SURFACE BOX TP10 TRAVERSE POINT & No. GV GATE VALVE WASH OUT WO FH FIRE HYDRANT WM WATER METER DAV DOUBLE ORIFICE AIR VALVE METRES ABOVE SEA LEVEL △ MD18 BENCHMARK WITH ELEVATION R E V I S I O N S SIGN DATE APPROVE CHECKED CLIENT: THE CHIEF EXECUTIVE OFFICER

ATHI WATER WORKS DEVELOPMENT

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 $\overline{ ext{MIBP}}$  mangat i.b patel (Mibp) Limited E P.O BOX 48674,00100-GPO,

NAIROBI, KENYA E-MAIL: mibp nairobi@mibp.co.ke TEL: +254-2-2710500

PROJECT NAME: CKE1135- NAIROBI WATER AND SANITATION PROJECT

CONTRACT TITLE:

CONSTRUCTION WORKS FOR GIGIRI - KARURA - OUTER RING ROAD TRANSMISSION PIPELINE AND NORTH NAIROB WATER AND SEWERAGE PROJECT

BID No. AWWDA/AFD/NWSP/W-02B/2023

TRUNK MAIN GIGIRI KARURA PIPELINE

DRAWING TITLE:

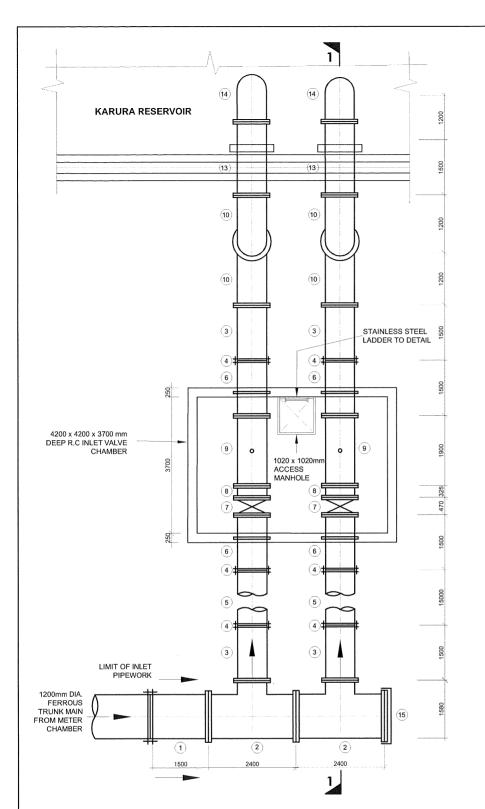
GIGIRI-KARURA OUTER-RING TRUNK MAIN

PLAN & LONGITUDINAL SECTION

FITTINGS DETAILS SHEET 5 OF 6

Drawn by: SWR Designed by: SWR hecked by: J.M.K Approved by: C.R


DRG No. M455/W-02B/W/GK/05



### **INLET PIPEWORK DETAIL**

SCALE 1:100

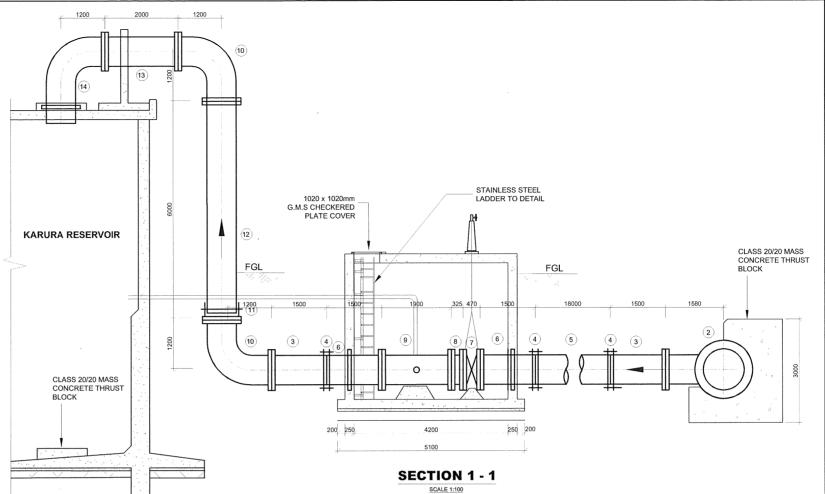ITEM No.	DESCRIPTION	DIA. (mm)	LENGTH (mm)	QUANTITY (No.)
12	FLANGED SPIGOT PIPE (CUT TO SUIT ON SITE)	800	6000	2
13)	ALL FLANGED PIPE	800	2000	2
14)	FLANGED SPIGOT 90° SPECIAL BEND WITH PUDDLE FLANGE 450mm FROM PLAIN END	800Ø		2
(15)	BLANK FLANGE	1200	-	1



### INLET PIPEWORK SCHEDULE (APPROVED LINED FERROUS PIPES AND FITTINGS)

ITEM No.	DESCRIPTION	DIA. (mm)	LENGTH (mm)	QUANTITY (No.)
1	FLANGED SPIGOT PIPE (CUT TO SUIT ON SITE)	1200	1500	1
2	ALL FLANGED TEE	1200Ø I 2400	1200Ø	2
3	FLANGED SPIGOT PIPE	800	1500	4
<b>(4</b> )	COUPLING	800	-	6
(5)	PLAIN ENDED PIPE WITH COUPLINGS (CUT TO SUIT ON SITE)	800	15000	2
6	FLANGED SPIGOT PIPE WITH PUDDLE FLANGE AT 880mm FROM FLANGED END	800	1500	4
(7)	ALL FLANGED BUTTERFLY VALVE	800	470	2
8	ALL FLANGED DISMANTLING JOINT	800	325	2
9	ALL FLANGED FLOW CONTROL VALVE WITH INTEGRATED ALTITUDE VALVE FUNCTION	800	1900	2
(10)	ALL FLANGED 90° BEND	1200	0Ø - 1 800Ø	4
(1)	FLANGE ADAPTOR	800	-	2

### NOTES:

- ALL DIMENSIONS ARE IN MM UNLESS OTHERWISE STATED
- FOR LADDER DETAILS, SEE DRG, No. M455/W-02B/SD/06
- FOR COVER DETAILS, SEE DRG. No. M455/W-02B/SD/08
- ALL REINFORCED CONCRETE IN CLASS 25/20 UNLESS OTHERWISI STATED
- ALL EXPOSED CONCRETE ED) ES HAVE A 25mmX25mm CHAMFER
- ALL FITTINGS ARE FERROUS TYPE RIGID JOINTED BY BUTT-WEI DING AND/OR MECHANICAL/ELEXIBLE JOINTED
- (FLANGED, COUPLING OR SOCKET AND SPIGOT JOINT)
- PRESSURE RATING FOR ALL WASHOUT PIPEWORK AND FITTINGS CORRESPOND TO THE PRESSURE RATING OF THE MAIN PIPELINE
- GATE VALVES HAVE IN-BUILT SOLATING VALVES

 R E	V 1	S	10	N S		SIGN	DATE	APPROVED
					BY			
					CHECKED			
					BY			
					CHECKED			
					BY			
					CHECKED			

### CLIENT:

### THE CHIEF EXECUTIVE OFFICER ATHI WATER WORKS DEVELOPMENT

P.O. BOX 45283 - 00100 NAIROBI TEL: 020 - 2727438 FAX: 2724295

CONSULTING ENGINEERS:

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### MIBP MANGAT I.B PATEL (MIBP) LIMITED

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BID No. AWWDA/AFD/NWSP/W-02B/2023

### TRUNK MAIN GIGIRI KARURA OUTER-RING

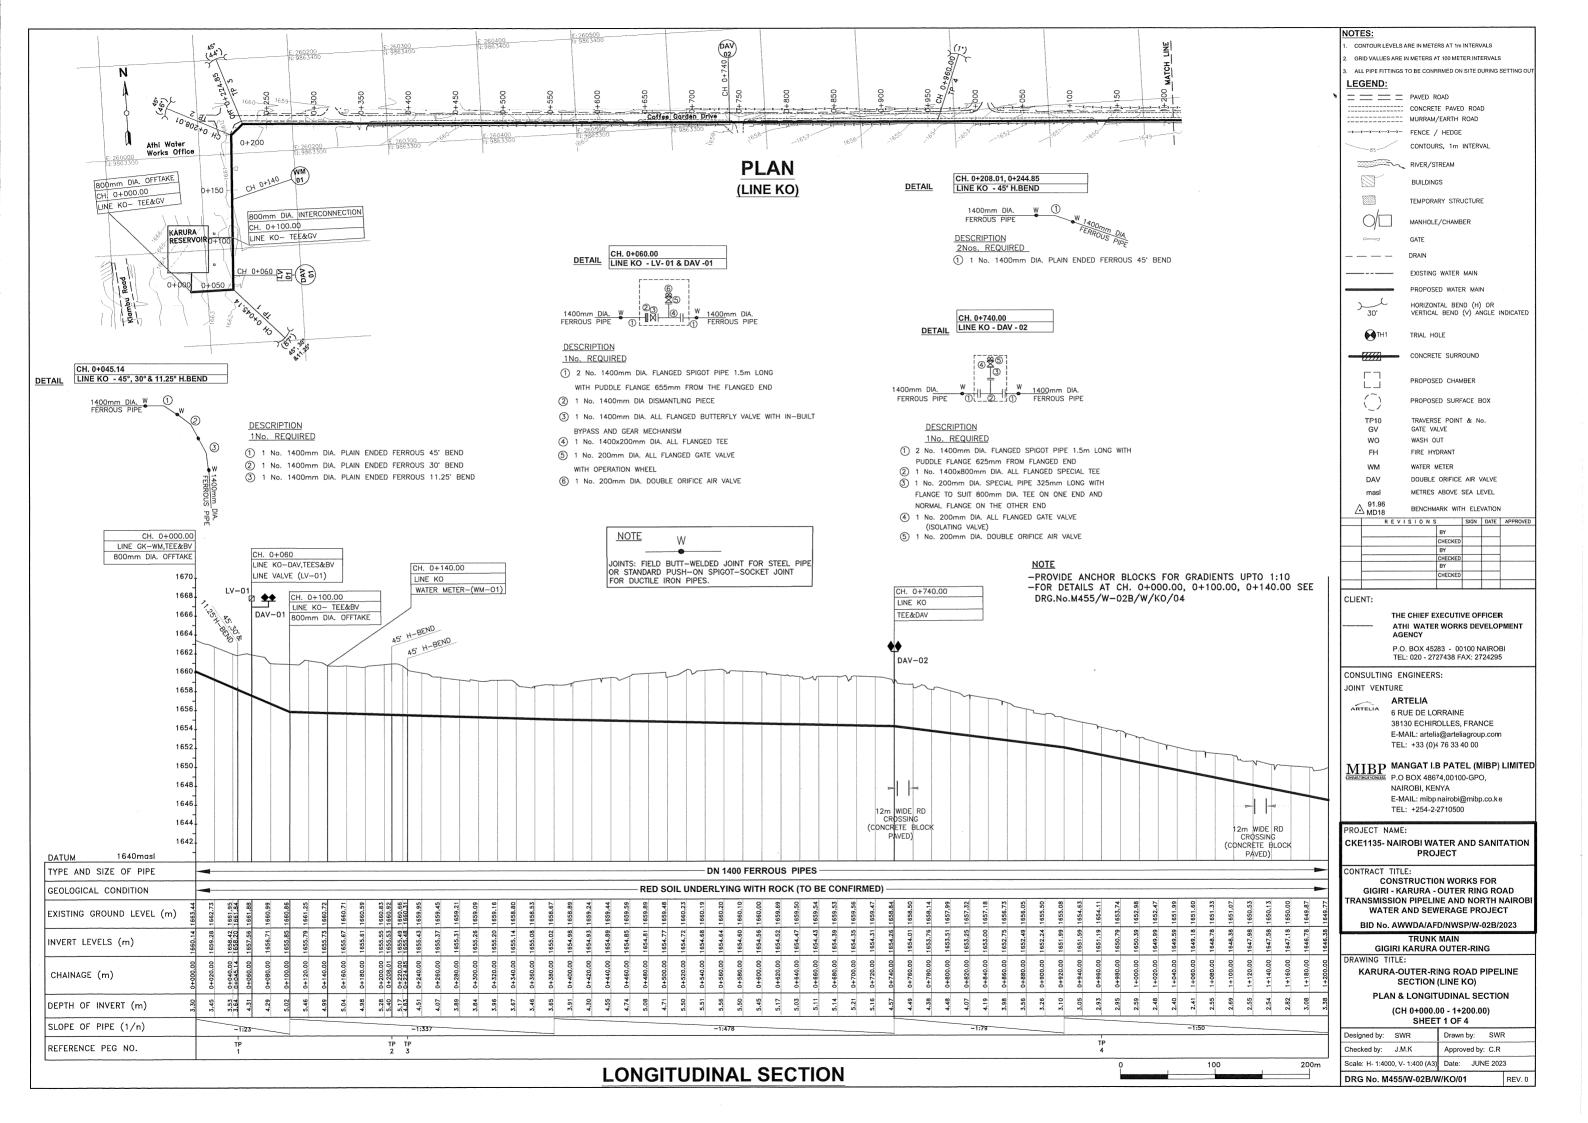
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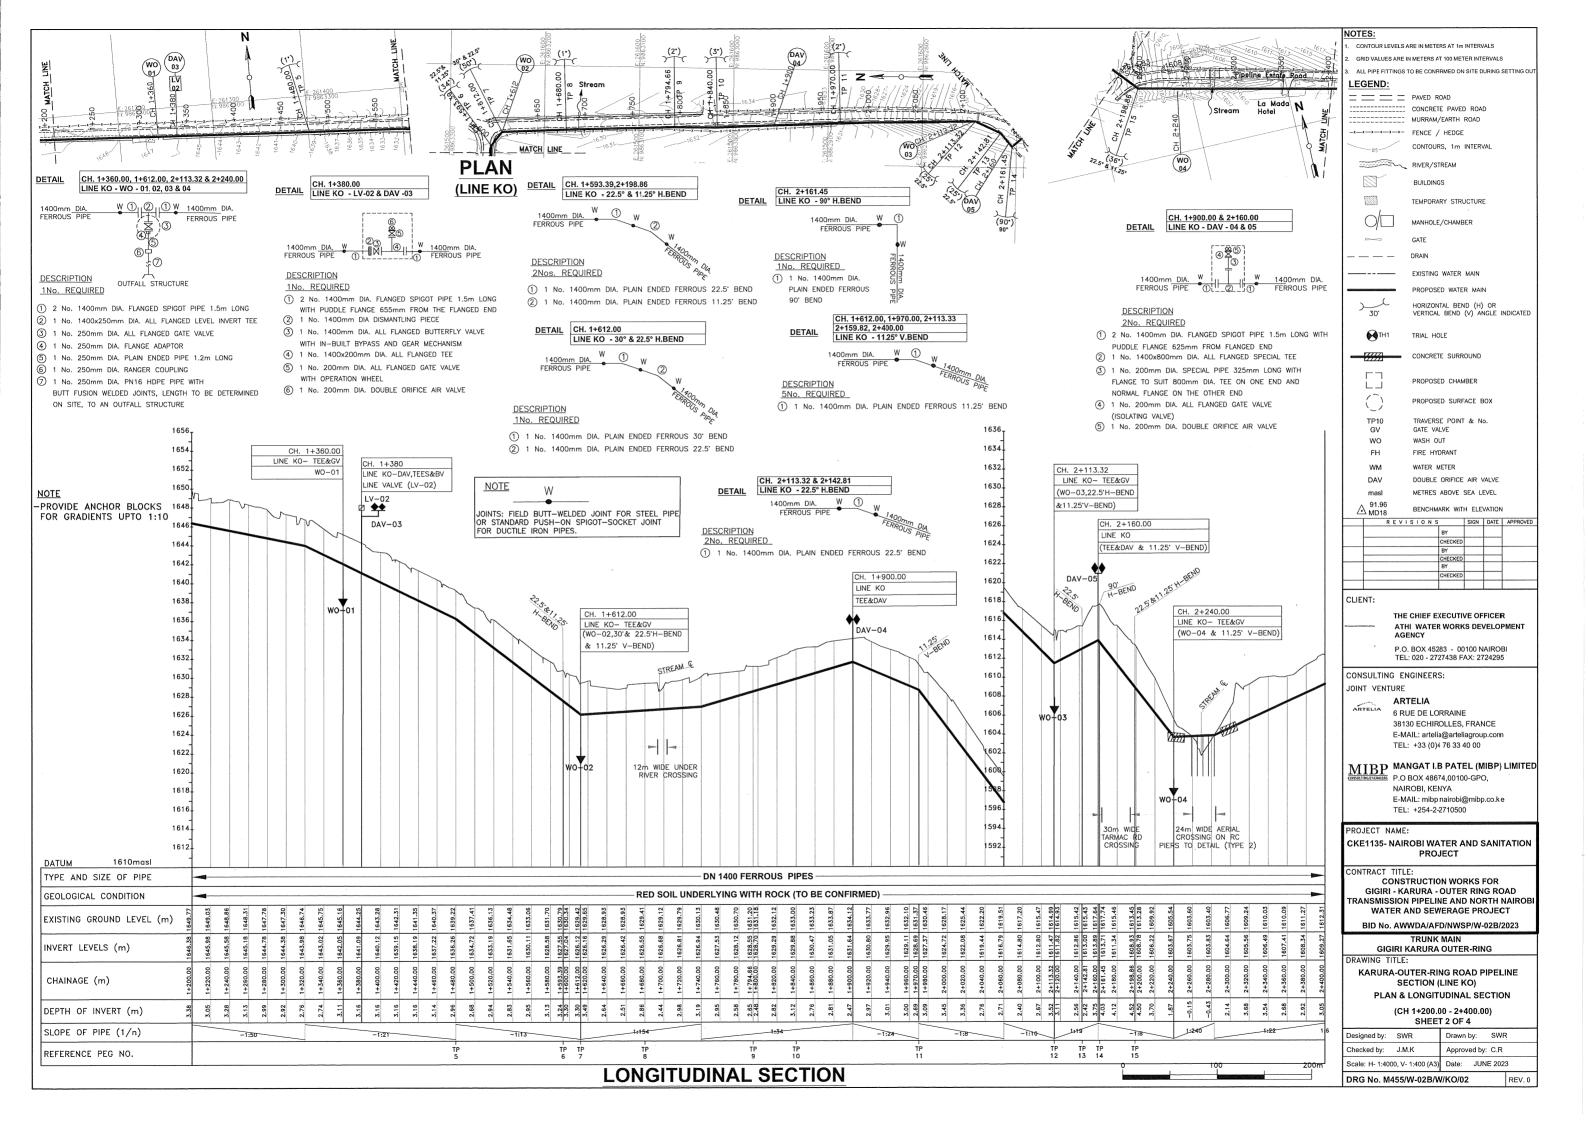
INTAKE VALVE CHAMBER & FITTINGS DETAILS

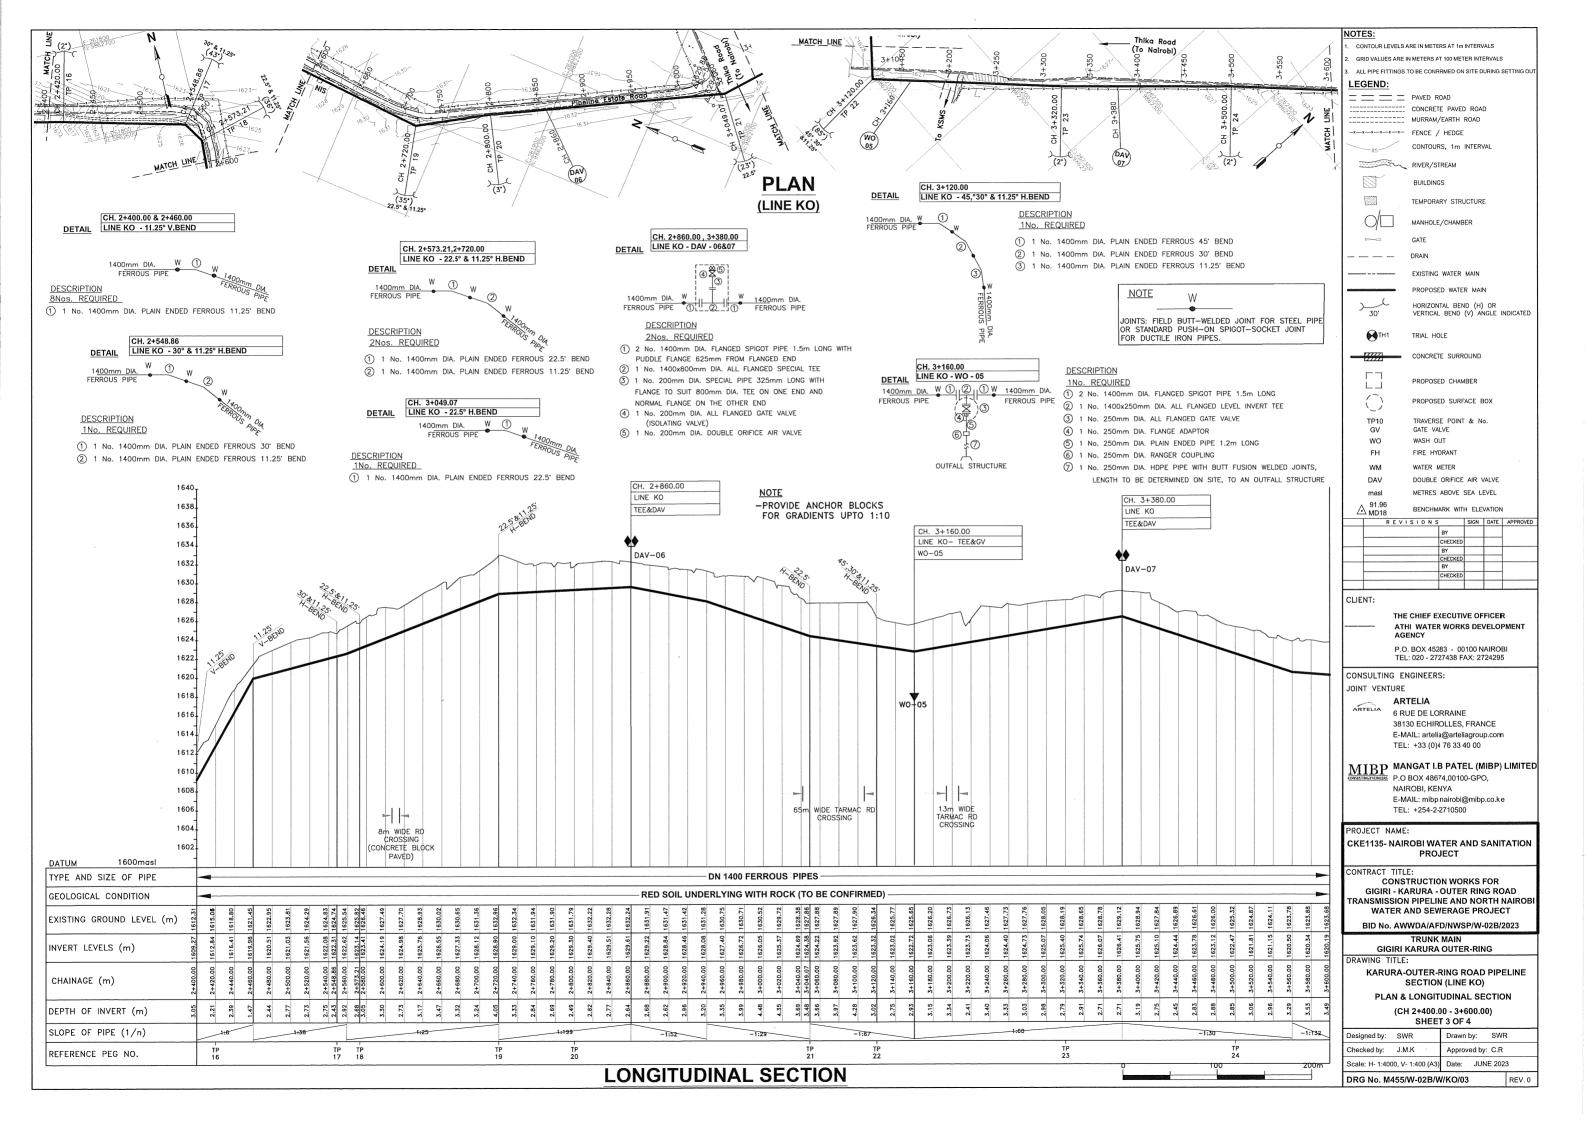
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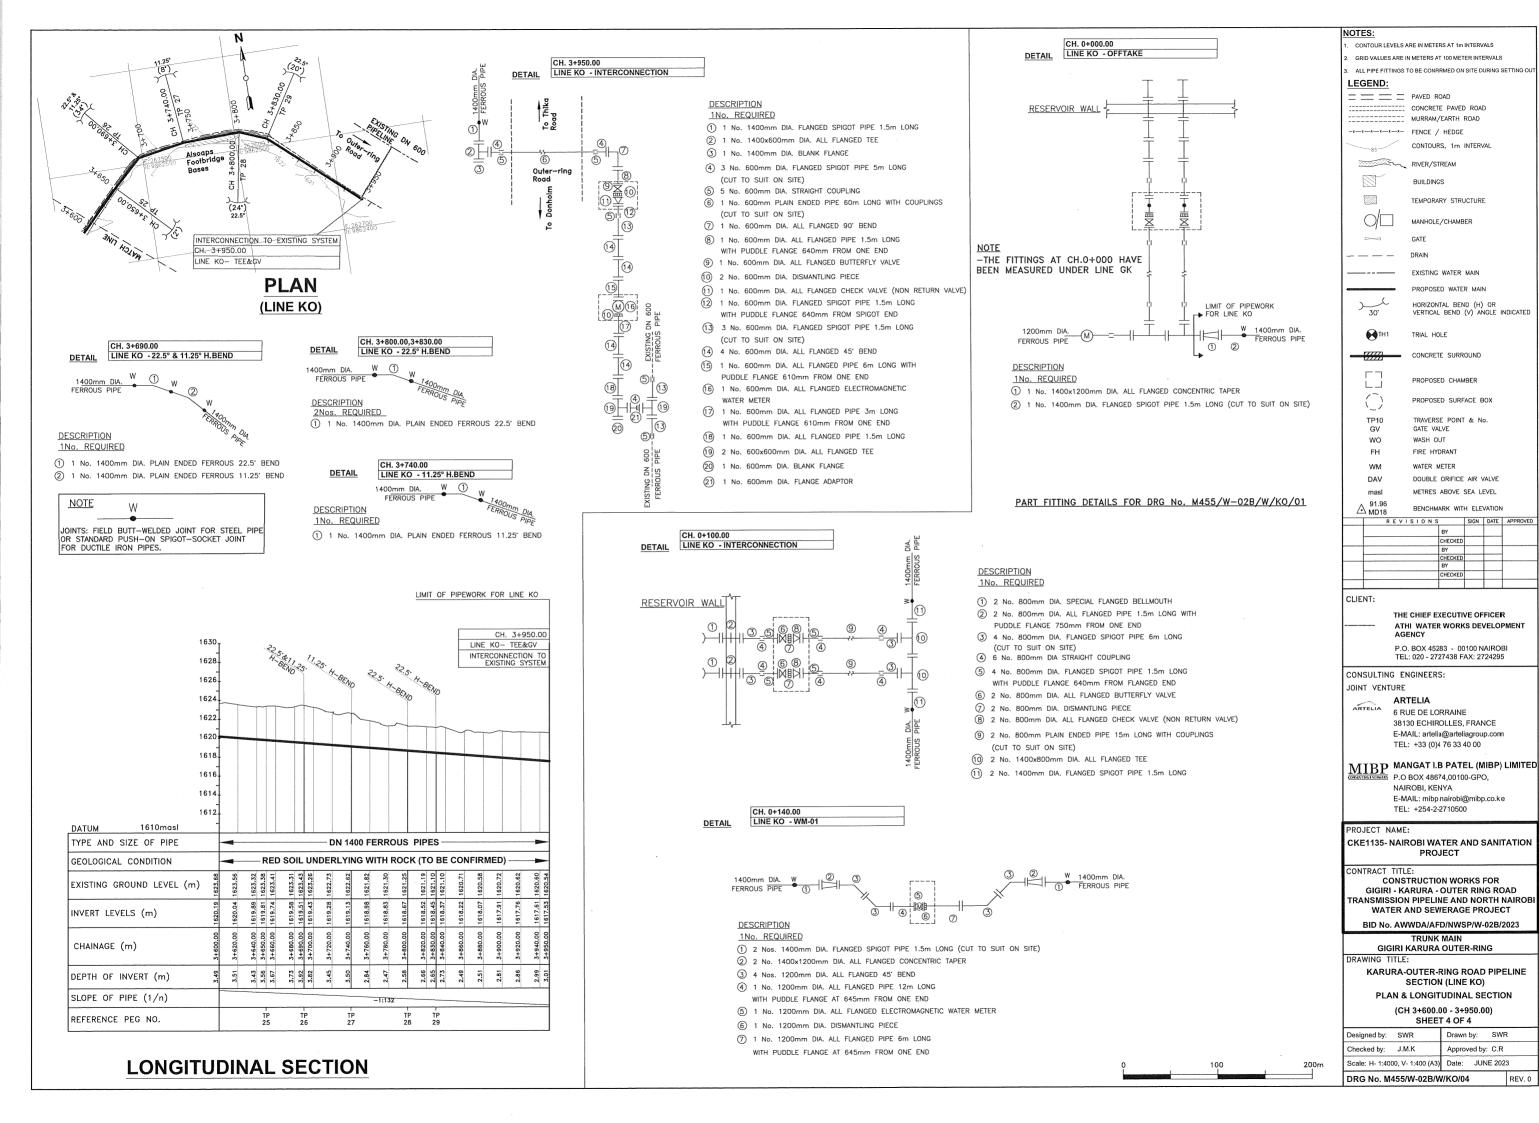
DRG No	. M455/W-02	B/W/Gł	(/06	REV. 0
Scale:	AS SHOWN	Date:	JUNE 2	2023
Checked by:	J.M.K	Approv	ed by: C	.R
Designed by:	J.M.K	Drawn	by: S	.W.R

# KARURA - OUTERING ROAD PIPELINE SECTION (LINE KO)









CHECKED

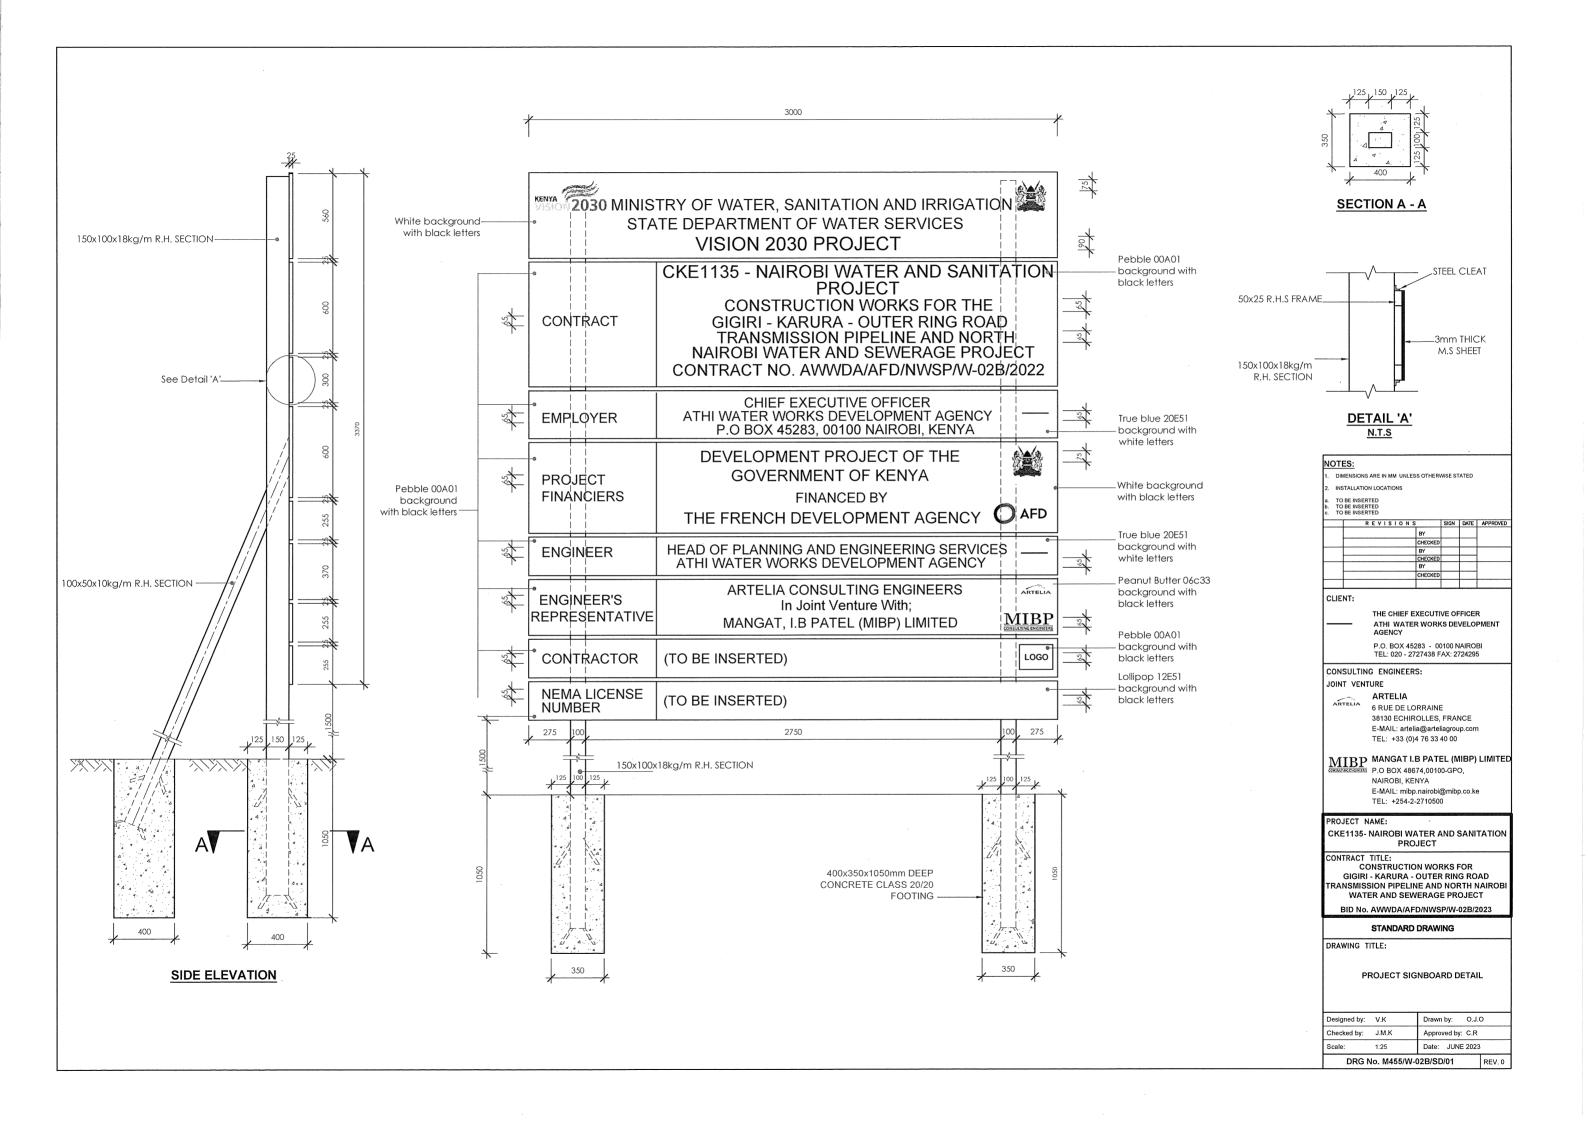
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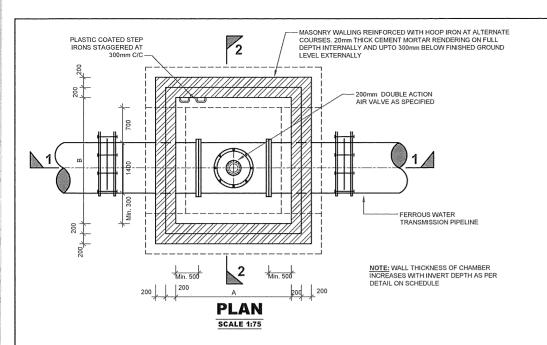
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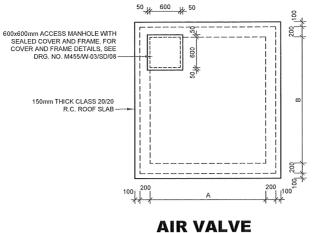
Approved by: C.R

SWR

# **STANDARD DRAWINGS**







150mm THICK CLASS 25/20

250

200 1 200 200 200 200 200

**SECTION 2-2** 

**CHAMBER ROOF** 

DETAIL

200mm DOUBLE ACTION AIR VALVE AS SPECIFIED

VENT (ONE BLOCK OMITTED) WITH PLASTIC COATED WIRE GAUZE

BELOW VENT LEVEL)

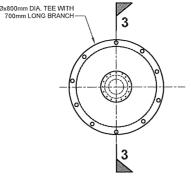
0mm THICK CLASS 25/20 R.C. WALL

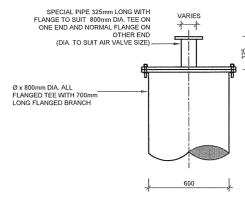
APPROVED GRANULAR MATERIAL COMPACTED TO 95% MDD OR AS DIRECTED BY THE ENGINEER ON SITE

- ALL FLANGED TEE WITH 800mm DIA. 1150mm LONG FLANGED BRANCH

200mm THICK CLASS 25/20 R.C. FOOTING

FINISHED GROUND LEVEL (MINIMUM 400mm





**PLAN** SCALE 1:40 **SECTION 3-3 SCALE 1:40** 

**DETAIL '1'** 

# NOTE:

FOR CHAMBER DEPTHS >3000mm, R.C. 1500mm x 1500mm CHAMBER TO BE ADOPTED

- 2. THE PIPEWORK MATERIAL PIPELINE IS FERROUS TYPE TO DESIGN PRESSURE RATING, AS SPECIFIED
- 3. RIGID JOINT REFERS TO BUTT WELDED JOINT WHILE. FLEXIBLE JOINT REFERS TO COUPLING, FLANGED OR SOCKET AND SPIGOT JOINT
- 4. FOR FITTINGS SCHEDULES, SEE RESPECTIVE PLAN AND PROFILE DRAWINGS AT LOCATION OF AIR VALVES

# STANDARD AIR VALVE CHAMBER

**DIMENSIONS SCHEDULE** 

MAIN PIPE DIA Ø (mm)	PLAN SIZE (INTERNAL DIMENSIONS) A(mm) x B(mm)
1400	2400 x 2200

### **GENERAL NOTES:**

- PRESSURE RATING FOR ALL AIR VALVE PIPEWORK AND FITTINGS TO PN 16

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	TEL: +33 (0)4 76 33 40 00
AITDD	MANGAT I.B PATEL (MIBP) LIMITE

38130 ECHIROLLES, FRANCE

ALL DIMENSIONS ARE IN mm UNLESS OTHERWISE STATED

ALL REINFORCED CONCRETE IN CLASS 25/20 UNLESS OTHE

ALL EXPOSED CONCRETE EDGES HAVE A 25mmX25mm CHAMFER

ALL FITTINGS ARE FERROUS TYPE RIGID JOINTED BY BUTT-WELDING AND/OR MECHANICAL/FLEXIBLE JOINTED (FLANGED, COUPLING OR SOCKET AND SPIGOT JOINT)

FOR COVER DETAILS, SEE DRG, No. M455/W-028/SD/08

STATED

ABBREVIATIONS

G.M.S

CLIENT:

MILLIMETRES FINISHED GROUND LEVEL

DIAMETER

DIAMETER REINFORCED CONCRETE

LENGTH

PIPE INVERT LEVEL

GALVANIZED MILD STEEL MILD STEEL CENTRE TO CENTRE

CONSULTING EVIGINEESS P.O BOX 48674,00100-GPO, NAIROBI, KENYA

CHECKED

THE CHIEF EXECUTIVE OFFICER

P.O. BOX 45283 - 00100 NAIROBI

ATHI WATER WORKS DEVELOPMENT

E-MAIL: mibp.nairobi@mibp.co.ke TEL: +254-2-2710500

PROJECT NAME:

CONSULTING ENGINEERS:

ARTELIA 6 RUE DE LORRAINE

JOINT VENTURE

CKE1135- NAIROBI WATER AND SANITATION PROJECT

CONTRACT TITLE:

CONSTRUCTION WORKS FOR GIGIRI -KARURA - OUTER RING ROAD TRANSMISSION PIPELINE AND NORTH NAIROBI WATER AND SEWERAGE PROJECT

BID No. AWWDA/AFD/NWSP/W-02B/2023

STANDARD DRAWING

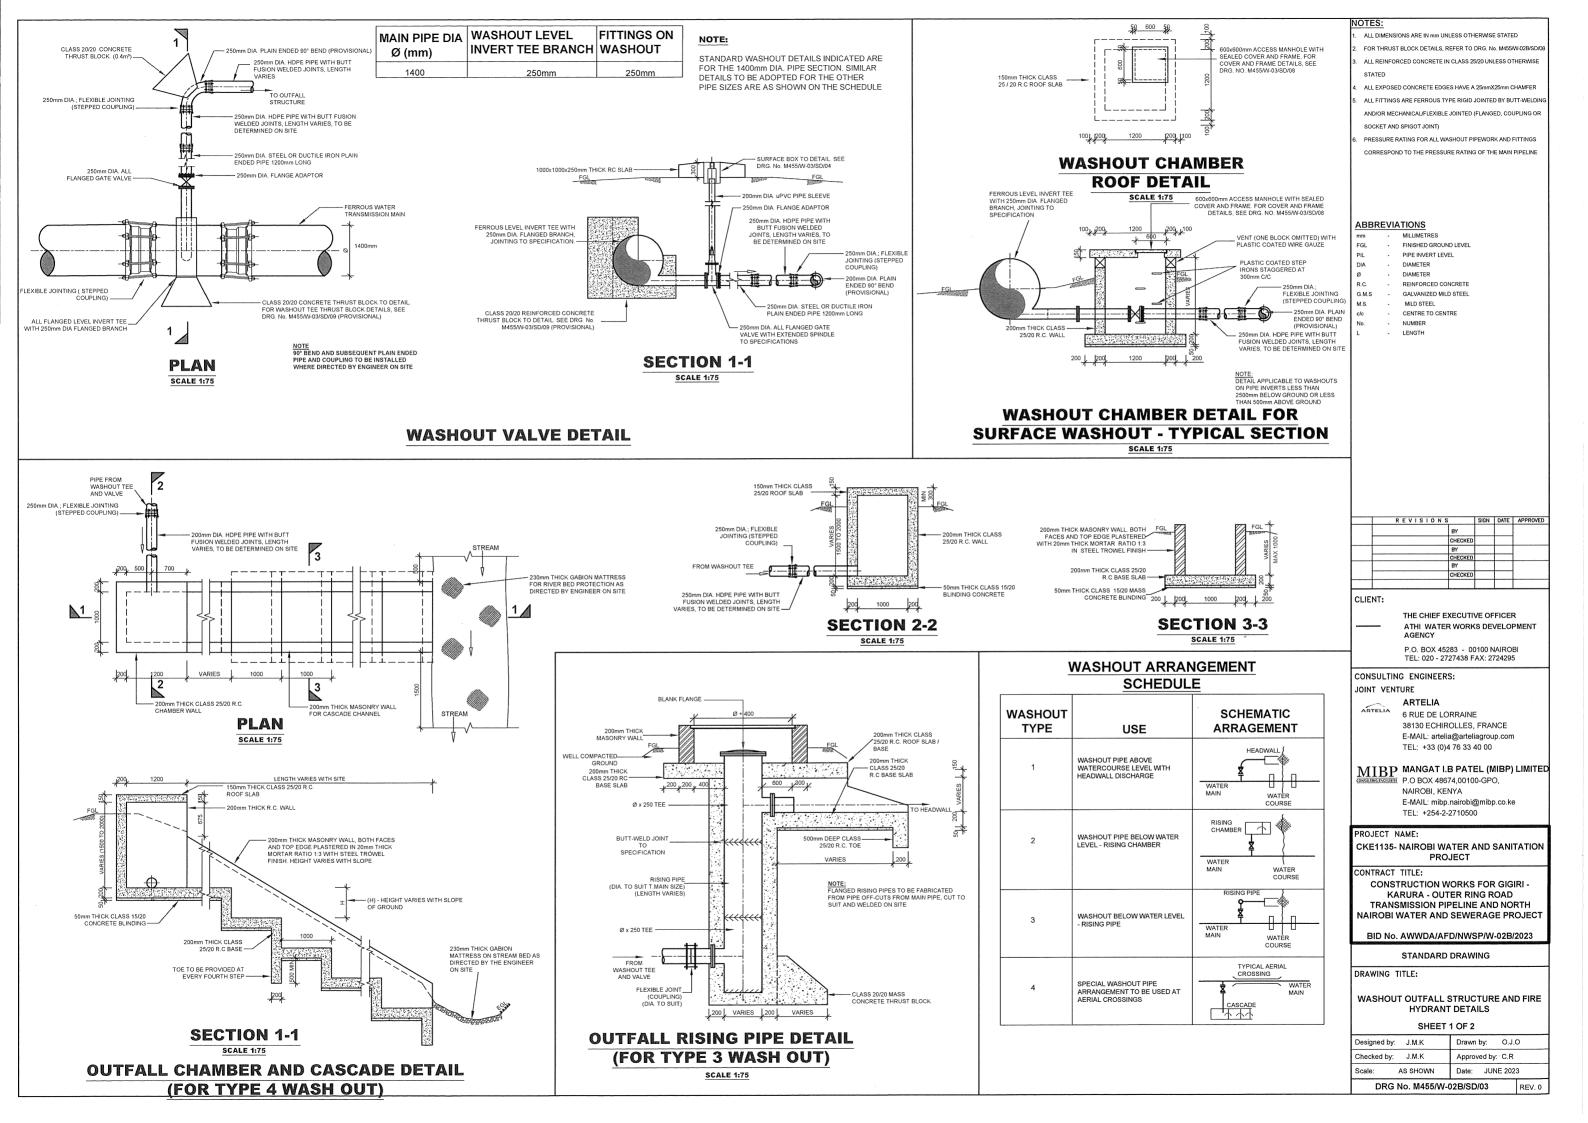
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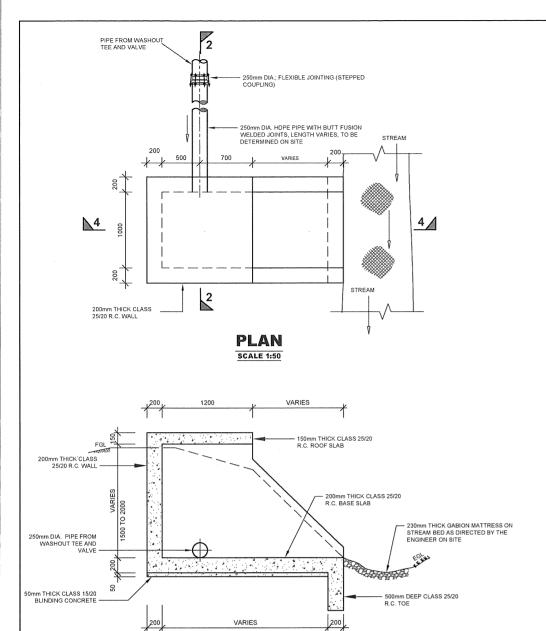
AIR VALVE CHAMBERS AND FITTINGS

Designed	by: J.M.K	Drawn by: O.J.	0		
Checked	by: J.M.K	Approved by: C.R			
Scale:	AS SHOWN	Date: JUNE 202	3		
DRG No. M455/W-02B/SD/02 REV. 0					

	200mm DOUBLE ACTION	
600x600mm ACCESS MANHOLE WITH SEALED COVER AND FRAME. FOR COVER AND FRAME DETAILS, SEE DRG. NO. M455/W-03/SD/08	AIR VALVE AS SPECIFIED	
250	150mm THICK CLASS 25/20 R.C ROOF SLAB	
100	VENT (ONE BLOCK OMITTED) WITH PLASTIC COATED WIRE GAUZE	
STAGGERED AT 300mm C/C		
200mm GATE VALVE	250mm THICK CLASS 25/20 R.C. WALL	
(ISOLATING VALVE)  (DIA. TO SUIT AIR  VALVE)  NORMAL TRENCH  BACKFILLING TO  DETAIL'11'	APPROVED GRANULAR MATERIAL COMPACTED TO 95% MDD OR AS DIRECTED BY THE ENGINEER ON SI	
SPECIFICATIONS	95% MIDD OR AS DIRECTED BY THE ENGINEER ON SI	16
	500 RODE TO THE RO	
9	PIL	
250 B	1400mm FERROUS WATER TRANSMISSION PIPELINE	
FLEXIBLE JOINT —————	STEEL ALL FLANGED TEE WITH 1400mm DIA. 1150mm LONG FLANGED BRANCH 200mm THICK CLASS 25/20 R.C. FOOTING	
Į 1500 Į VA	ARIES ( 1500 (	









# HEADWALL DETAIL (FOR TYPE 1 WASH OUT)

**SECTION 4-4** 

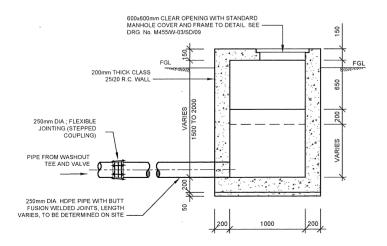SCALE 1:50



SECTION 6-6

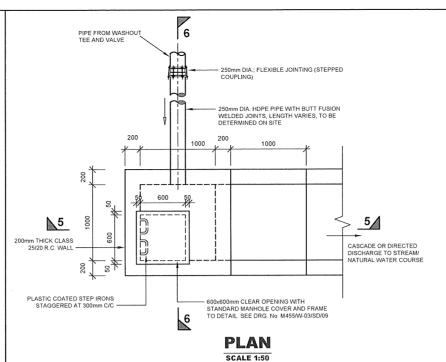


# FIGURE PLASTIC COATED STEP IRONS STAGGERED AT 300mm CIC CASCADE OR DIRECTED DISCHARGE TO STREAM NATURAL WATER COURSE R.C. SLAB S0mm THICK CLASS 25/20 R.C. SLAB S0mm THICK CLASS 25/20 CONCRETE BLINDING

# SECTION 5-5

# RISING OUTLET CHAMBER DETAIL (FOR TYPE 2 WASH OUT)

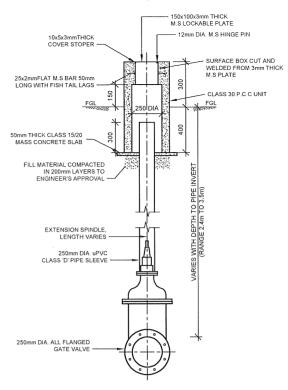NOTE:APPLICABLE WHERE WASHOUT OUTLET
IS BELOW WATER COURSE LEVEL



### **SECTION A-A**

SCALE 1:25

400 x 300mm DIA. P.C.C UNIT

20mm DIA. LIFTING HOLE

PLAN SCALE 1:25

### **DETAIL 1 - SURFACE BOX DETAIL**

MAIN PIPE DIA	WASHOUT LEVEL	FITTINGS ON
Ø (mm)	INVERT TEE BRANCH	WASHOUT
1400	250mm	250mm

### NOTE:

STANDARD WASHOUT DETAILS INDICATED ARE FOR THE 1400mm DIA. PIPE SECTION. SIMILAR DETAILS TO BE ADOPTED FOR THE OTHER PIPE SIZE ARE AS SHOWN ON THE SCHEDULE

### NOTE

- ALL DIMENSIONS ARE IN MM UNLESS OTHERWISE STATED
   FOR THRUST BLOCK DETAILS, REFER TO DRG. No. M455W-02B/SD/
- 3. ALL REINFORCED CONCRETE IN CLASS 25/20 UNLESS OTHERWISE
- ALL EXPOSED CONCRETE EDGES HAVE A 25mmX25mm CHAMFER
- ALL FITTINGS ARE FERROUS TYPE RIGID JOINTED BY
- BUTT-WELDING AND/OR MECHANICAL/FLEXIBLE JOINTED (FLANGE COUPLING OR SOCKET AND SPIGOT JOINT)
- PRESSURE RATING FOR ALL WASHOUT PIPEWORK AND FITTINGS
  CORRESPOND TO THE PRESSURE RATING OF THE MAIN PIPELINE

### ABBREVIATIONS

GL - FINISHED GROUND LEVEL

IL - PIPE INVERT LEVEL

Ø - DIAMETER
R.C. - REINFORCED CONCRETE
G.M.S - GALVANIZED MILD STEEL

M.S. - MILD STEEL
c/c - CENTRE TO CENTRE
No. - NUMBER

- LENGTH

### CLIENT:

THE CHIEF EXECUTIVE OFFICER
ATHI WATER WORKS DEVELOPMENT

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TEL: +254-2-2710500

### PROJECT NAME:

CKE1135- NAIROBI WATER AND SANITATION PROJECT

### CONTRACT TITE

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BID No. AWWDA/AFD/NWSP/W-02B/2023

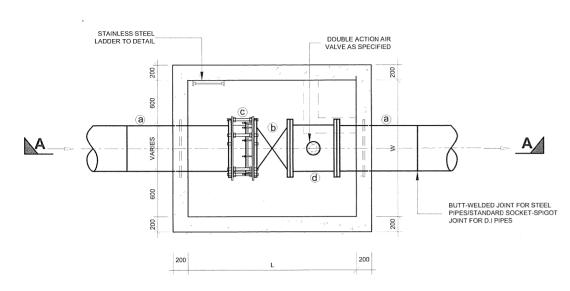
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DRAWING TITLE:

WASHOUT OUTFALL STRUCTURE AND FIRE HYDRANT DETAILS


### SHEET 2 OF 2

Designed	by: J.M.K	Drawn by:	O.J.	0
Checked b	oy: J.M.K	Approved b	y: C.R	
Scale:	AS SHOWN	Date: JU	3	
DR	G No. M455/W-	02B/SD/04		REV. 0



# TYPE 1 INLINE VALVE CHAMBER PLAN

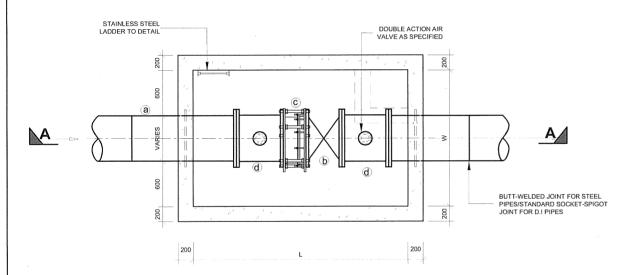SCALE 1:50





### TYPE 2 INLINE VALVE CHAMBER PLAN

SCALE 1:50

### CHAMBER INTERNAL PLAN DIMENSIONS

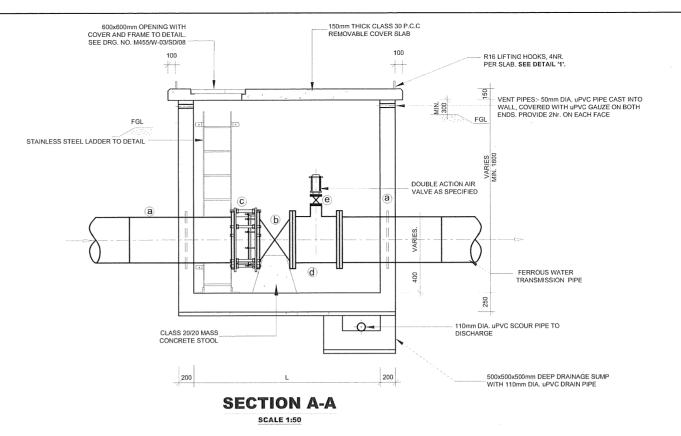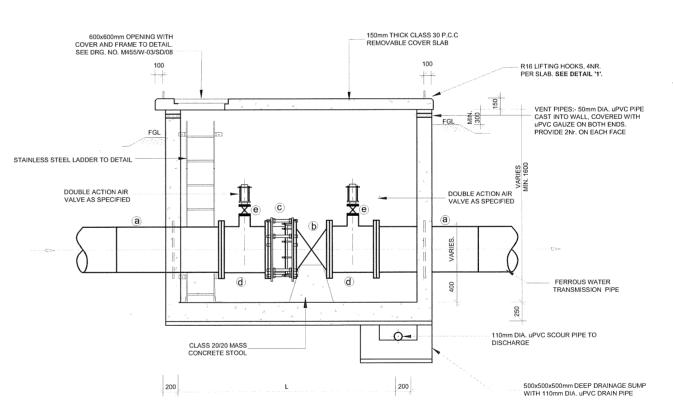PIPE DIA. (mm)	OFF TAKE GATE VALVE CHAMBER L(mm) x W(mm)	LINE VALVE CHAMBER (TYPE1) L(mm) x W(mm)	LINE VALVE CHAMBER(TYPE 2) L(mm) x W(mm)	LINE VALVE CHAMBER(TYPE 3) L(mm) x W(mm)
1400	-	2800 x 2600	-	-
1000	-	2400 x 2200	-	-
800	1800 x 1800	-	-	-
600	1600 x 2400	-	-	-





# SECTION A-A

# SCHEDULE OF FITTINGS FOR INLINE VALVE CHAMBER (TYPE 1, 2 AND 3)

S/Nr.	DESCRIPTION	Nr.
а	FLANGED SPIGOT 1500/1200mm LONG WITH PUDDLE FLANGE (LOCATION OF PUDDLE FLANGE VARIES)	2
b	ALL FLANGED BUTTERFLY VALVE	1
С	DISMANTLING PIECE	1
d	ALL FLANGED TEE (DIA TO SUIT T. PIPELINE)	1
е	ALL FLANGED GATE VALVE (DIA. TO SUIT AIR VALVE)	1

### NOTES:

- ALL DIMENSIONS ARE IN MM UNLESS OTHERWISE STATED
- FOR COVER DETAILS, SEE DRG. No. M455/W-02B/SD/08
- ALL REINFORCED CONCRETE IN CLASS 25/20 UNLESS OTHERWISE
   STATED
- 4. ALL EXPOSED CONCRETE EDGES HAVE A 25mmX25mm CHAMFER
- . ALL FITTINGS ARE FERROUS TYPE RIGID JOINTED BY
  BUTT-WELDING AND/OR MECHANICAL/FLEXIBLE JOINTED
  (FLANGED, COUPLING OR SOCKET AND SPIGOT JOINT)
- 6. PRESSURE RATING FOR ALL WASHOUT PIPEWORK AND FITTINGS
- 7. GATE VALVES HAVE IN-BUILT ISOLATING VALVES

REVISION	N S	SIGN	DATE	APPROVED
	BY			
	CHECKED			
	BY			
	CHECKED			
	BY			
	CHECKED			

CLIENT:

THE CHIEF EXECUTIVE OFFICER
ATHI WATER WORKS DEVELOPMENT
AGENCY

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PROJECT NAME

CKE1135- NAIROBI WATER AND SANITATION PROJECT

CONTRACT TITLE:

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BID No. AWWDA/AFD/NWSP/W-02B/2023

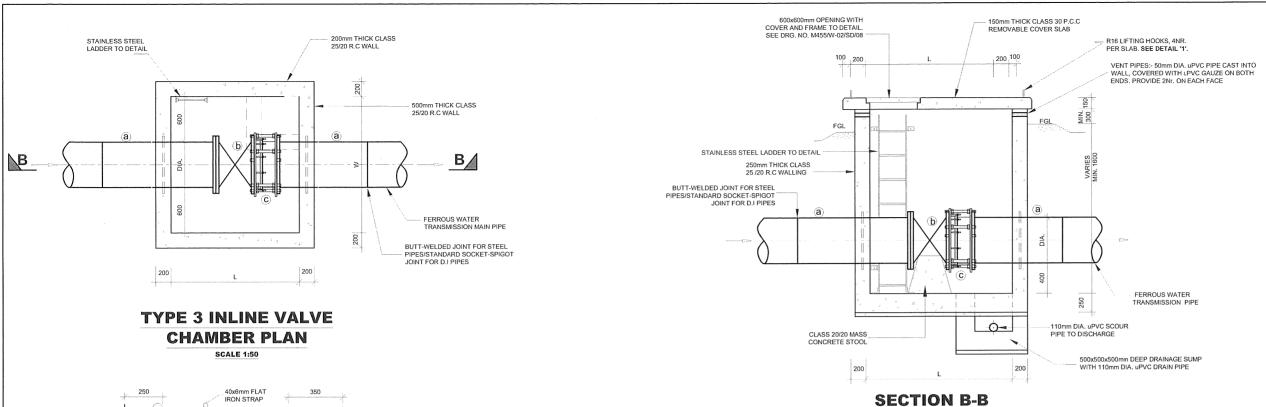
STANDARD	DRAWING

DRAWING TITLE:

INLINE/OFFTAKE VALVE CHAMBER, FITTINGS AND ACCESS LADDER

### SHEET 1 OF 2


Designed by:	J.M.K	Drawn by: O.J.	0
Checked by:	J.M.K	Approved by: C.R	
Scale:	AS SHOWN	Date: JUNE 202	3
DRG N	No. M455/W-0	02B/SD/05	REV. 0



### M12 BOLT, NUT AND WASHER 65X12 STAINLESS STEEL STRINGERS 100x75x12mm THICK ANGLE SEE DETAIL 2 - M12 RAWL BOLT DN 20 STAINLESS STEEL RUNGS AT 300 C/C **DETAIL 2 - AT WALL** R.C. CHAMBER WALL & BASE SCALE 1:5 40x6mm 600mm DIA. G.M.S SAFETY HOOPS AT 600mm C/C. SEE DETAIL 3 6mm THICK SAFETY HOOPS 600mm DIA. FIXED TO STRINGERS WITH M12 BOLTS AT 600mm C/C M12 RAWL BOLT 65X12mm M.S STRINGERS 20mm Ø M.S RUNGS 350 M20 BOLT NUT 40x6mm FLAT IRON STRAPS WELDED ON TO 40x6mm FLAT G.M.S. SAFETY HOOPS 600mm DIAMETER **DETAIL 3 - SAFETY** SEE DETAIL 2 HOOPS **SCALE 1:25**

LADDER DETAIL

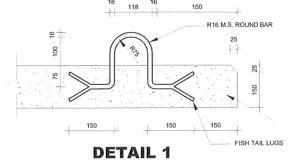**SCALE 1:25** 



SCALE 1:50

**LIFTING EYE DETAIL** SCALE 1:20

NOTES:

ALL DIMENSIONS ARE IN MM UNLESS OTHERWISE STATED

FOR COVER DETAILS, SEE DRG. No. M455/W-02B/SD/08

ALL DEINEODOED CONCRETE IN CLASS 25/20 LINEESS OTHERWIS

ALL EXPOSED CONCRETE EDGES HAVE A 25mmX25mm CHAMFER

ALL FITTINGS ARE FERROUS TYPE RIGID JOINTED BY BUTT-WELDING AND/OR MECHANICAL/FLEXIBLE JOINTED

PRESSURE RATING FOR ALL WASHOUT PIPEWORK AND FITTINGS

GATE VALVES HAVE IN-BUILT ISOLATING VALVES

CLIENT:

THE CHIEF EXECUTIVE OFFICER ATHI WATER WORKS DEVELOPMENT AGENCY

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BID No. AWWDA/AFD/NWSP/W-02B/2023


STANDARD DRAWING

DRAWING TITLE:

INLINE/OFFTAKE VALVE CHAMBER, FITTINGS AND ACCESS LADDER

SHEET 2 OF 2


Designed by:	J.M.K	Drawn by: O.J.O
Checked by:	J.M.K	Approved by: C.R
Scale:	AS SHOWN	Date: JUNE 2023

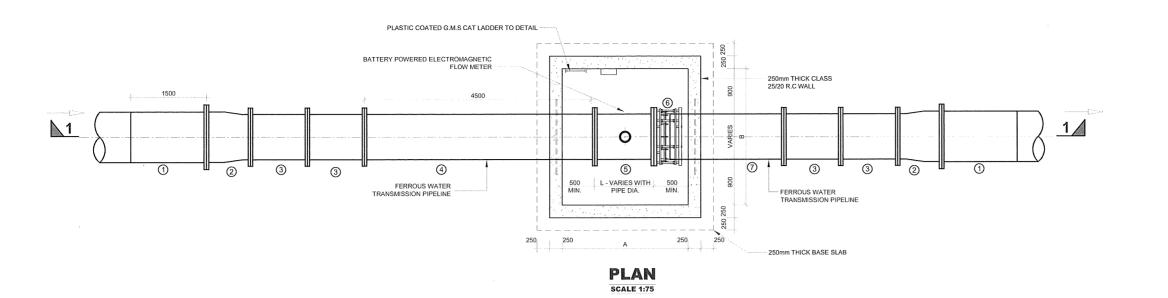

600x600mm OPENING WITH COVER AND FRAME TO DETAIL SEE DRG. NO. M455/W-03/SD/08 R16 LIFTING EYES, 4NR. PER SLAB. SEE DETAIL '1' 100 - 150mm THICK CLASS 30 P.C.C REMOVABLE COVER SLAB IN 2 PIECES WALL MOUNTED 400x400x200mm VENT PIPES:- 50mm DIA. uPVC PIPE CAST INTO WALL, COVERED WITH uPVC GAUZE ON BOTH ENDS. PROVIDE 2Nr. ON EACH FACE DEEP WEATHERPROOF METALLIC HOUSING, FOR REMOTE DISPLAY AND BATTERY WALL MOUNTED DATA LOGGER PLASTIC COATED G.M.S LADDER TO DETAIL 250mm THICK CLASS L- VARIES 25 /20 R.C WALLING 2 2 FERROUS WATER
TRANSMISSION PIPELINE 4 (5) 6 FERROUS WATER TRANSMISSION PIPELINE 0-110mm DIA. uPVC SCOUR PIPE TO DISCHARGE BATTERY POWERED ELECTROMAGNETIC FLOW METER, ISOMAG MODEL AS MANUFACTURED BY ISOIL INDUSTRIA 250 250 500x500x500mm DEEP DRAINAGE SUMP

# SECTION 1-1
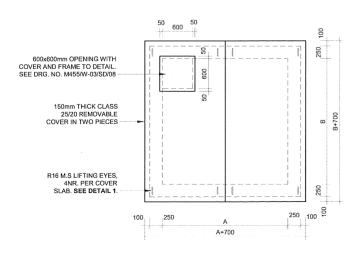
### **ELECTROMAGNETIC METER CHAMBER**



# METER CHAMBER ROOF DETAIL SCALE 1:75

### TYPICAL ELECTROMAGNETIC METER CHAMBER SCHEDULE OF FITTINGS

S/Nr.	DESCRIPTION	Nr.
1	FLANGED SPIGOT PIPE 1500/1200mm LONG	2
2	1400 x 1200 mm ALL FLANGED CONCENTRIC TAPER	2
3	ALL FLANGED 45° BEND	4
4	DOUBLE FLANGED PIPE WITH PUDDLE FLANGE (MIN. LENGTH 5 x DIA.). LOCATION OF PUDDLE FLANGE VARIES	2
5	ALL FLANGED BATTERY POWERED ELECTROMAGNETIC WATER METER, COMPLETE WITH REMOTE LED DISPLAY AND REQUISITE FITTINGS	1
6	DISMANTLING PIECE	1
7	FLANGED SPIGOT PIPE WITH PUDDLE FLANGE (MIN. LENGTH 2.5 x DIA.). LOCATION OF PUDDLE FLANGE VARIES	1

### STANDARD ELECTROMAGNETIC METER CHAMBER DIMENSIONS SCHEDULE

MAIN PIPE DIA Ø (mm)	PLAN SIZE (INTERNAL DIMENSIONS) A(mm) x B(mm)				
1400	2600 x 3000				
1000	2400 x 2800				
800	2200 x 2600				
600	2200 x 2400				

### NOTES:

- ALL DIMENSIONS ARE IN mm UNLESS OTHERWISE STATED
- FOR COVER DETAILS, REFER TO DRG. No. M455W-02B/SD/08
- 3. ALL REINFORCED CONCRETE IN CLASS 25/20 UNLESS OTHERWISE
- ALL EXPOSED CONCRETE EDGES HAVE A 25mmX25mm CHAMFER
  - BUTT-WEI DING AND/OR MECHANICAL/FLEXIBLE JOINTED
  - ALL ANDER CONDING OF COOKET AND COICOT TO
  - PRESSURE RATING FOR ALL WASHOUT PIPEWORK AND FITTINGS

    CORRESPOND TO THE PRESSURE RATING OF THE MAIN PIPELINE

### ABBREVIATIONS

mm - MILLIMETRES
FGL - FINISHED GROUND LEVEL

PIL - PIPE INVERT LEVEL

Ø - DIAMETER

R.C. - REINFORCED CONCRETE

G.M.S - GALVANIZED WILD STEEL

M.S. - MILD STEEL

c/c - CENTRE TO CENTRE

No. - NUMBER

- LENGTH

### CLIENT:

THE CHIEF EXECUTIVE OFFICER
ATHI WATER WORKS DEVELOPMENT

AGENCY

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CONTRACT TITLE:

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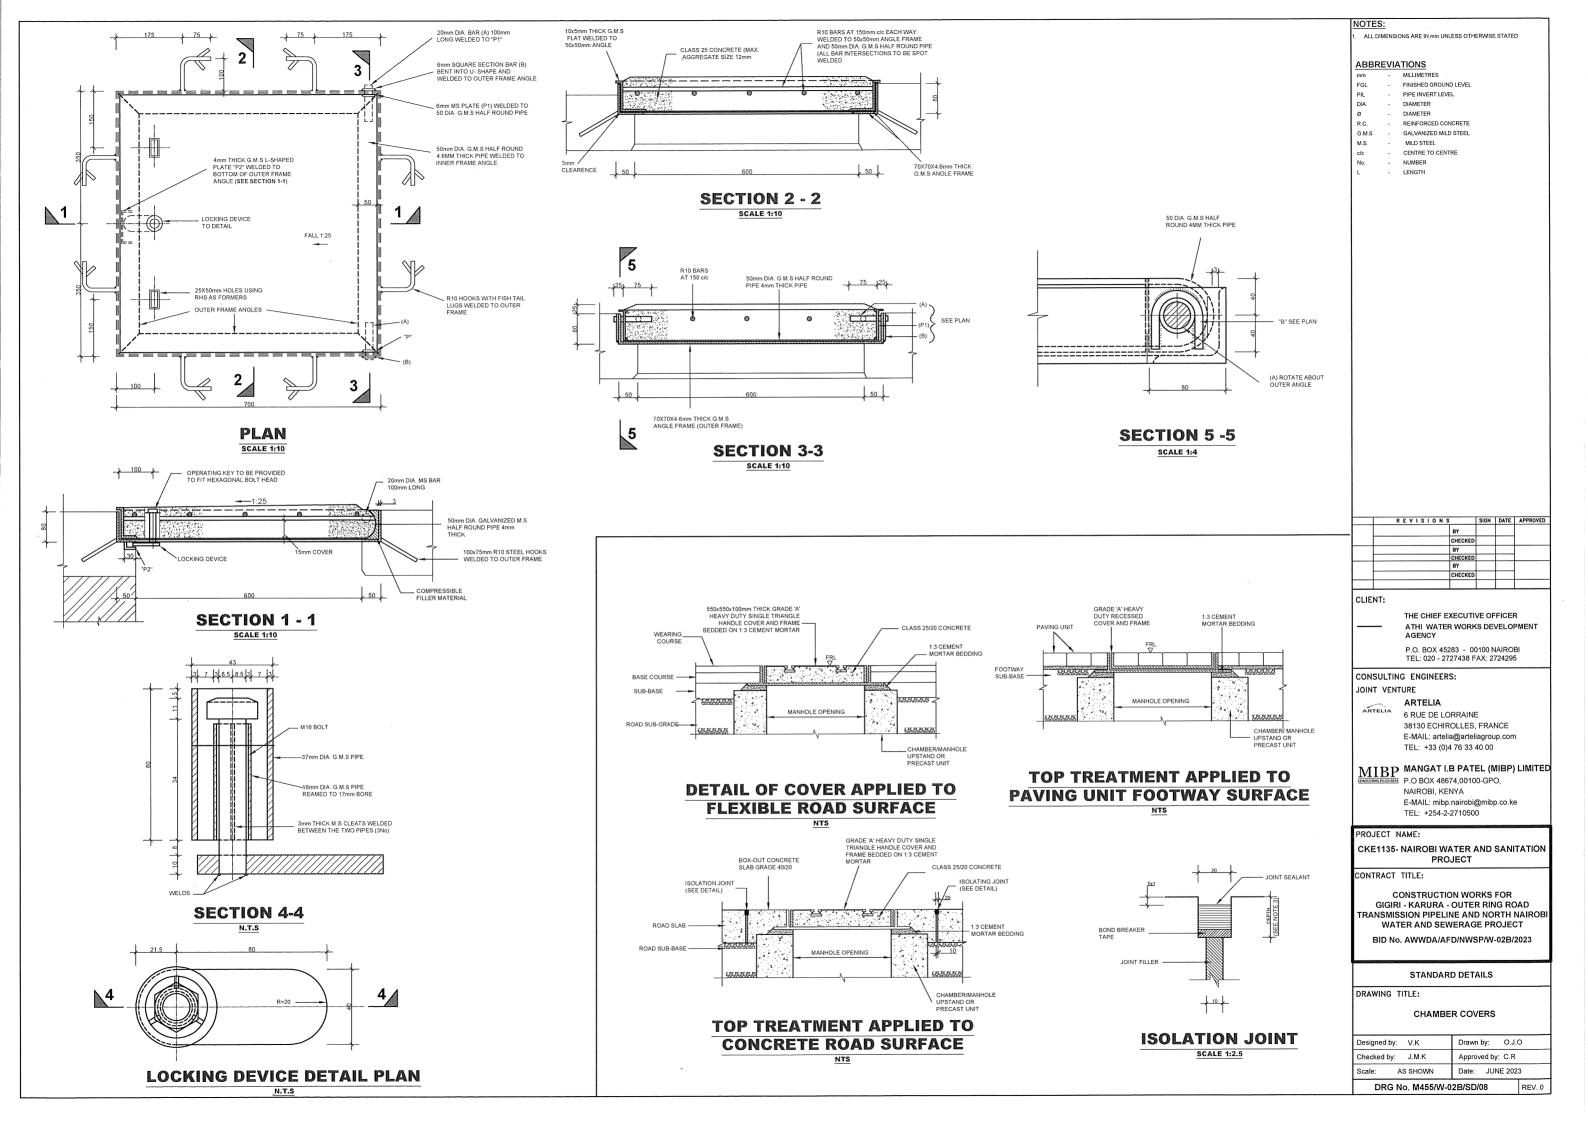
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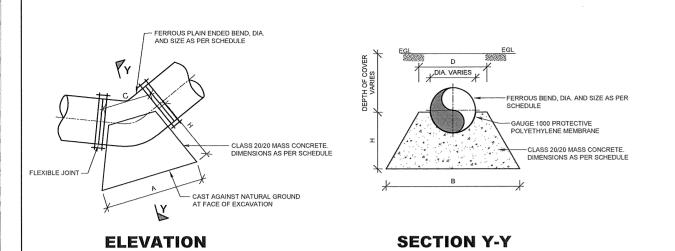
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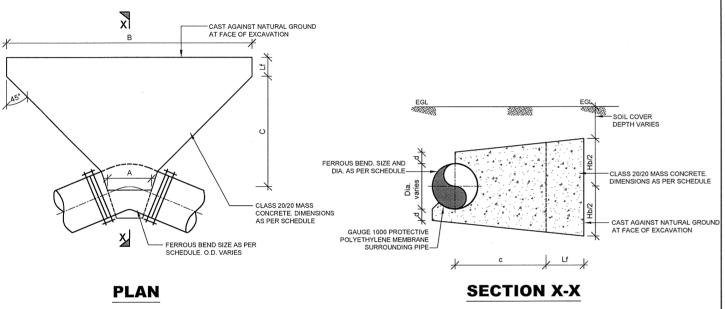
METER CHAMBER FITTINGS AND DETAILS

Designed	by: V.K	Drawn by: O	.J.O
Checked	by: J.M.K	Approved by: C	.R
Scale:	AS SHOWN	Date: JUNE 2	:023
DF	RG No. M455/W	-02B/SD/07	REV. 0





# THRUST BLOCK ON VERTICAL BENDS (DOWN THRUST)



# THRUST BLOCK DIMENSIONS

**THRUST BLOCK ON** 

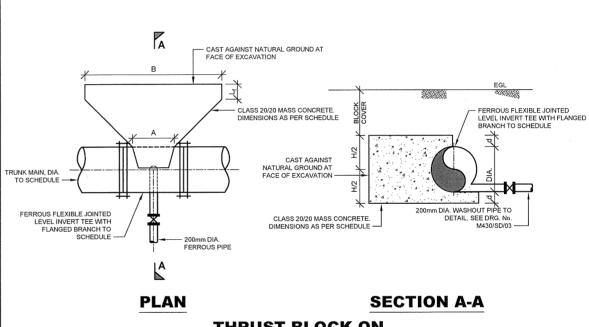
**HORIZONTAL BENDS** 

				HOR	IZON	TAL B	ENDS			VER	TICAL	. BEN	DS - D	OWN	THRUST
PIPE DIA	PRESSURE	ANGLE OF			DIME	NSIONS	(mm)					DIME	NSIONS	(mm)	MIN.
Ø(mm)	RATING (Bar)	BEND (Deg)	Α	В	С	d	L <sub>f</sub>	Нь	VOLUME (m <sup>3</sup> )	Α	В	С	D	Нь	VOLUME (m <sup>3</sup> )
		11.25	800	2000	2000	400	500	1400	3.67	2000	2000	800	1600	1000	2.12
		22.5	800	2200	2500	400	500	1800	7.24	2000	2000	800	1600	2000	4.63
1400	16	30	900	3000	3000	600	600	2600	15.36	2400	2400	800	1800	3000	9.67
1		45	1100	3500	3500	800	800	3800	31.24	3000	3000	800	1800	3800	19.3
i		90	1100	4300	4500	800	1000	4000	47.98	3200	3200	800	2500	4100	37.6


	THRUST BLOCK ON TEES									
MAIN	BRANCHING	PRESSURE			DIME	NSION	S (mm	)		
PIPE DIA Ø(mm)	PIPE DIA (mm)	RATING (Bar)	А	В	Нь	L	L <sub>f</sub>	VOLUME (m <sup>3</sup> )		
1400	1000	16	1200	8700	3000	3500	400	51.98		
1400	800	16	1200	7000	3500	3500	400	50.23		
1400	600	16	1100	6550	2400	2000	400	35.5		

# CLASS 20/20 MASS CONCRETE. DIMENSIONS AS PER SCHEDULE CLASS 20/20 MASS CONCRETE. DIMENSIONS AS PER SCHEDULE T FERROUS BEND, DIA. AND SIZE AS PER SCHEDULE FERROUS BEND, DIA. AND SIZE AS PER SCHEDULE SECTION Z-Z

# THRUST BLOCK ON VERTICAL BENDS (UP THRUST)



# THRUST BLOCK ON WASH-OUT TEE

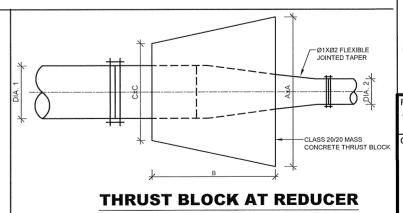

	THRUST BLOCKS ON TAPERS									
Ø <sub>1</sub>	Ø <sub>2</sub>	TEST DIMENSIONS (								
(mm)	(mm)	PRESSURE (Bar)	А	В	С	VOLUME (m³)				
1400	1200	16	2200	2000	1600	7.75				

### NOTE

- ALL DIMENSIONS ARE IN MM UNLESS OTHERWISE STATED
   ANCHOR BLOCKS TO BE INSTALLED FOR PIPES LAID AT SLOPES
   EXCEEDING 1.6 SLOPE
- THRUST BLOCKS INSTALLED AT ALL FLEXIBLE JOINTED
  HORIZONTAL AND VERTICAL BENDS, CAPPED ENDS, TEES, TAPERS
  AND GATE VALVES
  - ALL FITTINGS ARE FERROUS TYPE RIGID JOINTED BY

    BUTT-WELDING AND/OR MECHANICAL/FLEXIBLE JOINTED

    (FLANGED, COUPLING OR SOCKET AND SPIGOT JOINT)
  - ALL PIPE SURFACES IN CONTACT WITH CONCRETE WRAPPED W
    GAUGE 1000 POLYTHENE MEMBRANE PROTECTIVE LAYER

### ABBREVIATIONS

MILLIMETRES
 FINISHED GROUND LEVEL
 PIPE INVERT LEVEL

- DIAMETER

R.C. - REINFORCED CONCRETE
G.M.S - GALVANIZED MILD STEEL

.S. - MILD STEEL c - CENTRE TO CENTRE

. - CENTRETOCEN

- LENGTH n3 - CUBIC METER

REVISIONS		SIGN	DATE	APPROVED
	BY			
	CHECKED			
	BY			
	CHECKED			
	BY			
	CHECKED			

### CLIENT:

THE CHIEF EXECUTIVE OFFICER
ATHI WATER WORKS DEVELOPMENT

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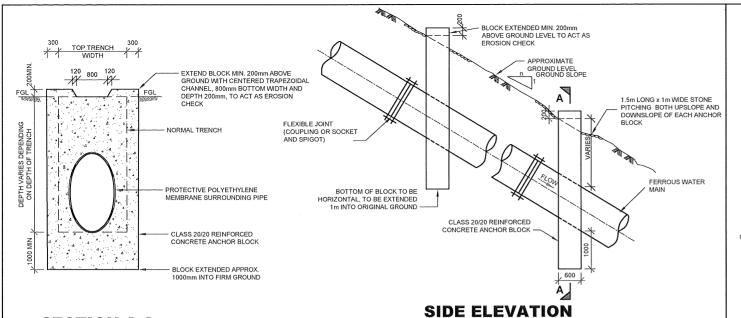
BID No. AWWDA/AFD/NWSP/W-02B/2023

### STANDARD DRAWING

### DRAWING TITLE:

### THRUST BLOCKS

Designed b	y: J.M.K	Drawn by:	O.J.0	)		
Checked b	y: J.M.K	Approved by: C.R				
Scale: AS SHOWN Date: JUNE 2023						
DP	DPG No. MASSMI 02B/SD/09					



### **SECTION A-A** SCALE 1:100

### NOTES

- 1. SAME ARRANGEMENT CAN BE USED AS SUPPORTS FOR PIPES LAID IN VERY SOFT GROUND BUT BLOCKS TO BE CAST ON SOUND ROCK OR HARD STRATUM
- 2. ANCHOR BLOCKS TO BE CONSTRUCTED ON LOWER SIDE OF
- UNLESS OTHERWISE INSTRUCTED, BUTT WELD JOINTED PIPES FOR STEEL AND SELF ANCHORING JOINTED PIPES FOR DUCTILE IRON WILL NOT REQUIRE ANCHOR BLOCKS

GROUND SLOPE

B

200 / 200 VARIES 200

CLASS 20/20 R.C ANCHOR BLOCK ON 200mm THICK BASE

### **ANCHOR BLOCK TYPE 1** PIPE LAID ALONG SLOPE (GRADIENT > 1:8

SCALE 1:100 MAXIMUM DISTANCE BETWEEN ANCHOR BLOCKS RANGE OF GROUND SLOPE 1:n TYPE 1 (ALONG SLOPE) (m) <1.8 1:10 - 1:6 1:6 - 1:5 24 1:5 - 1:4 1:4 - 1:2 12 EVERY PIPE LENGTH TO BE ANCHORED

(BASED ON PIPE LENGTH OF 6m) >1:2

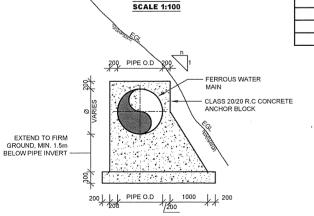
MAXIMUM DISTANCE

TYPE 2 (ACROSS SLOPE) (m

# m THICK CLASS 20/20 R.C BASE B 1000 200 BETWEEN ANCHOR BLOCKS RANGE OF GROUND SLOPE 1:n

1.4 - 1.2


>1.2



**PLAN** 

### **SECTION B-B**

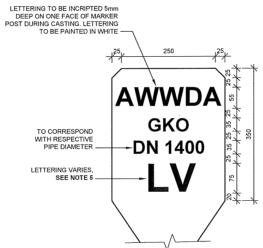**ANCHOR BLOCK TYPE 2** PIPE LAID ACROSS SLOPE (GRADIENT > 1:4)





### **DETAIL 1** LETTERING DETAIL

# **SCALE 1:10**

### NOTES:

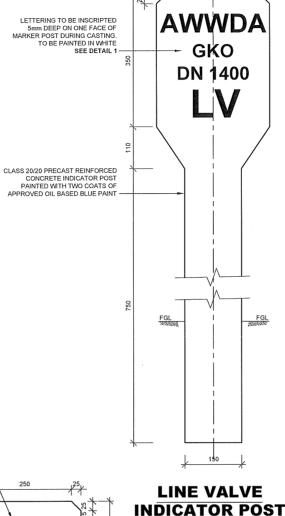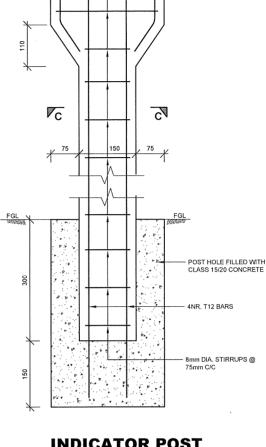- ALL INDICATOR POSTS TO BE PAINTED WITH TWO COATS OF BLUE OIL BASED PAINT AND WHITE LETTERING TO ENGINEER'S APPROVAL
- 2. INDICATOR POSTS TO BE PLACED AT ALL APPURTENANCE LOCATIONS, AND AT INTERVALS OF 250m, WITH THE UNSCRIPTED LETTERING FACING THE ACCESS ROAD






 $\sqrt{D}$ 


 $\overline{P}_{D}$ 

### **INDICATOR POST** REINFORCEMENT DETAILS

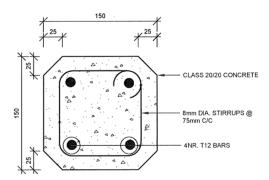**SCALE 1:10** 



### **SECTION C-C** SCALE 1:5

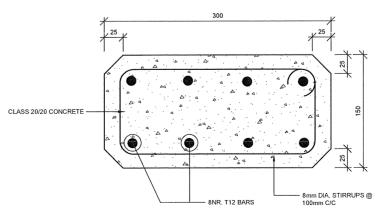

### **SECTION D-D**

### NOTES

- ALL DIMENSIONS IN mm UNLESS OTHERWISE STATED ALL FITTINGS ARE FERROUS TYPE RIGID JOINTED BY BUTT-WELD AND/OR MECHANICAL/FLEXIBLE JOINTED (FLANGED, COUPLING OF SOCKET AND SPIGOT JOINT)
- ANCHOR BLOCKS INSTALLED FOR PIPES LAID AT SLOPES EXCEEDING 1:8 FOR TYPE 1 BLOCKS AND SLOPES EXCEEDING 1:4 FOR TYPE 2 BLOCKS
  - DETAILS OF ALL INDICATOR POSTS ARE AS FOR LINE VALVE BUT LETTERING TO BE AS FOLLOWS:-

FOR	USE
LINE VALVE	LV
AIR VALVE	AV
WASHOUT	wo
WATER MAIN	WM

### **ABBREVIATIONS**

FINISHED GROUND LEVEL EXISTING GROUND LEVEL PIPE INVERTILEVEL DIAMETER OUTER DIAMETER R.C. REINFORCED CONCRETE CENTER TO CENTRE NUMBER CUBIC METER

AWWDA ATHI WATER WORKS DEVELOPMENT

CHECKE

### CLIENT:

THE CHIEF EXECUTIVE OFFICER ATHI WATER WORKS DEVELOPMENT AGENCY

P.O. BOX 45283 - 00100 NAIROBI TEL: 020 - 2727438 FAX: 2724295

### CONSULTING ENGINEERS:

### JOINT VENTURE ARTELIA

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NAIROBI, KENYA E-MAIL: mibp.nairobi@mibp.co.ke TEL: +254-2-2710500

### PROJECT NAME:

CKE1135- NAIROBI WATER AND SANITATION PROJECT

### CONTRACT TITLE:

CONSTRUCTION WORKS FOR GIGIRI KARURA - OUTER RING ROAD TRANSMISSION PIPELINE AND NORTH NAIROBI WATER AND SEWERAGE PROJECT

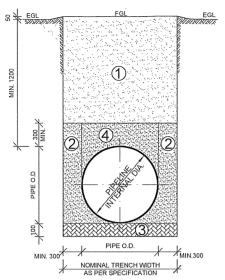
BID No. AWWDA/AFD/NWSP/W-02B/2023

### STANDARD DRAWING

DRAWING TITLE:

### ANCHOR BLOCKS AND INDICATOR

Designed	by: J.M.K	Drawn by: O.J.O				
Checked b	y: J.M.K	Approved by: C.R				
Scale: AS SHOWN Date: JUNE 2023						
DRG No. M455/W-02B/SD/10 REV. 0						



### TYPICAL NORMAL TRENCH DETAILS FOR WATER MAINS (FERROUS PIPES)

SCALE 1:100

SOIL TO BE USED MAY INCLUDE FREE-DRAINING COARSE SAND, GRAVEL, LOAM AND SOIL OF A FRIABLE NATURE. PARTICAL SIZE NOT TO EXCEED 20mm.

BACKFILL IN LAYERS NOT EXCEEDING 300mm UPTO FINISHED GROUND LEVEL, EACH LAYER BEING WELL COMPACTED TO LIMIT VOIDS. MECHANICAL COMPACTION EQUIPMENT MAY BE USED IF APPROVED BY ENGINEER.

EACKFILL WITH SOIL APPROVED BY THE ENGINEER, IN LAYERS NOT EXCEEDING 200mm.

THOROUGHLY COMPACT SOIL, TAMPING EQUALLY ON EITHER SIDE AND ALONG LOWER EDGE OF PIPE. ONLY HAND TAMPING TO BE USED.

ZONE

IF SHARP ROCK PROJECTIONS, TREE ROOTS OR OTHER UNSUITABLE MATTERIAL IS ENCOUNTERED AT TRENCH INVERT LEVEL, A FURTHER 100mm DEPTH OP MATERIAL IS TO BE EXCAVATED.

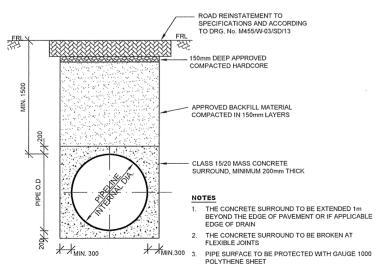
BACKFILL WITH SOIL APPROVED BY ENGINEER UPTO TRENCH INVERT LEVEL. THOROUGHLY COMPACT SOIL BY HAND TO GIVE A UNIFORM GRADIENT ALONG PIPE TRENCH, LEAVING RECESSES FOR PIPE JOINTS

ZONE SIMILAR REQUIREMENTS TO ZONE 2 EXCEPT NO EXCESS TAMPING IS PERMITTED OVER PIPE

NOTE:
TRENCH SIDE SLOPES AND EXTENDED WIDTH
AT CONTRACTOR'S DISCRETION DEPENDING ON
STABILITY OF EXCAVATED SURFACE TO ENSURE
ADEQUATE SAFETY TO LABOUR AT WORK ON
SITE, QUANTITIES TO BE MEASURED BASED ON
NOMINAL TRENCH WIDTH


### STANDARD TRENCH WIDTH


PIPE DIA	TRENCH WIDTH
(mm)	(mm)
1400	2000




# TYPICAL TRENCH REINSTATEMENT DETAIL AT ROAD CROSSINGS

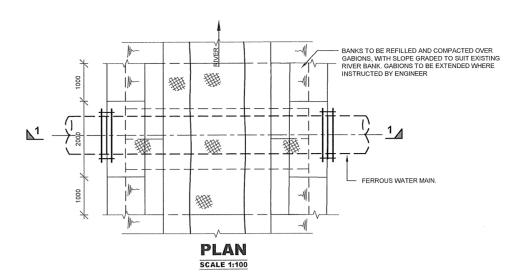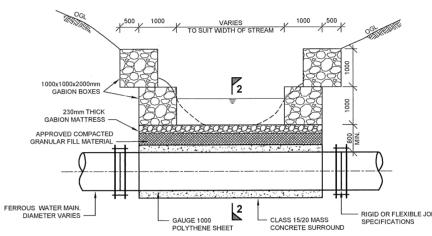SCALE 1:100





# SECTION 1-1

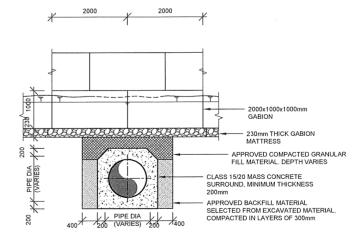

# SECTION 2-2

TYPICAL UNDER- RIVER CROSSING

### OTES:

- ALL DIMENSIONS IN mm UNLESS OTHERWISE STATED
- ALL PIPE SURFACES IN CONTACT WITH CONCRETE ARE WRAPPED IN GAUGE 1000 POLYTHENE SHEET
- 3. MASS CONCRETE SURROUND IN CLASS 15/20 UNLESS OTHERWISE STATED
- ALL FITTINGS ARE FERROUS TYPE RIGID JOINTED BY BUTT-WELE AND/OR MECHANICAL/FLEXIBLE JOINTED (FLANGED, COUPLING O SOCKET AND SPIGOT JOINT)

### ABBREVIATIONS

mm	-	MILLIMETRES
FGL.	-	FINISHED GROUND LEVI
EGL	-	EXISTING GROUND LEVI
O.G.L	-	ORIGINAL GROUND LEV
DIA	-	DIAMETER
FRL	-	FINISHED ROAD LEVEL
۵	-	CENTER LINE

	REVISION:	S	SIGN	DATE	APPROVED
		BY			
		CHECKED			
		BY			
		CHECKED			
		BY			
		CHECKED			
-					

### CLIENT:

THE CHIEF EXECUTIVE OFFICER
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TEL: +254-2-2710500

### PROJECT NAME:

CKE1135- NAIROBI WATER AND SANITATION PROJECT

### CONTRACT TITLE:

CONSTRUCTION WORKS FOR GIGIRI -KARURA - OUTER RING ROAD TRANSMISSION PIPELINE AND NORTH NAIROBI WATER AND SEWERAGE PROJECT

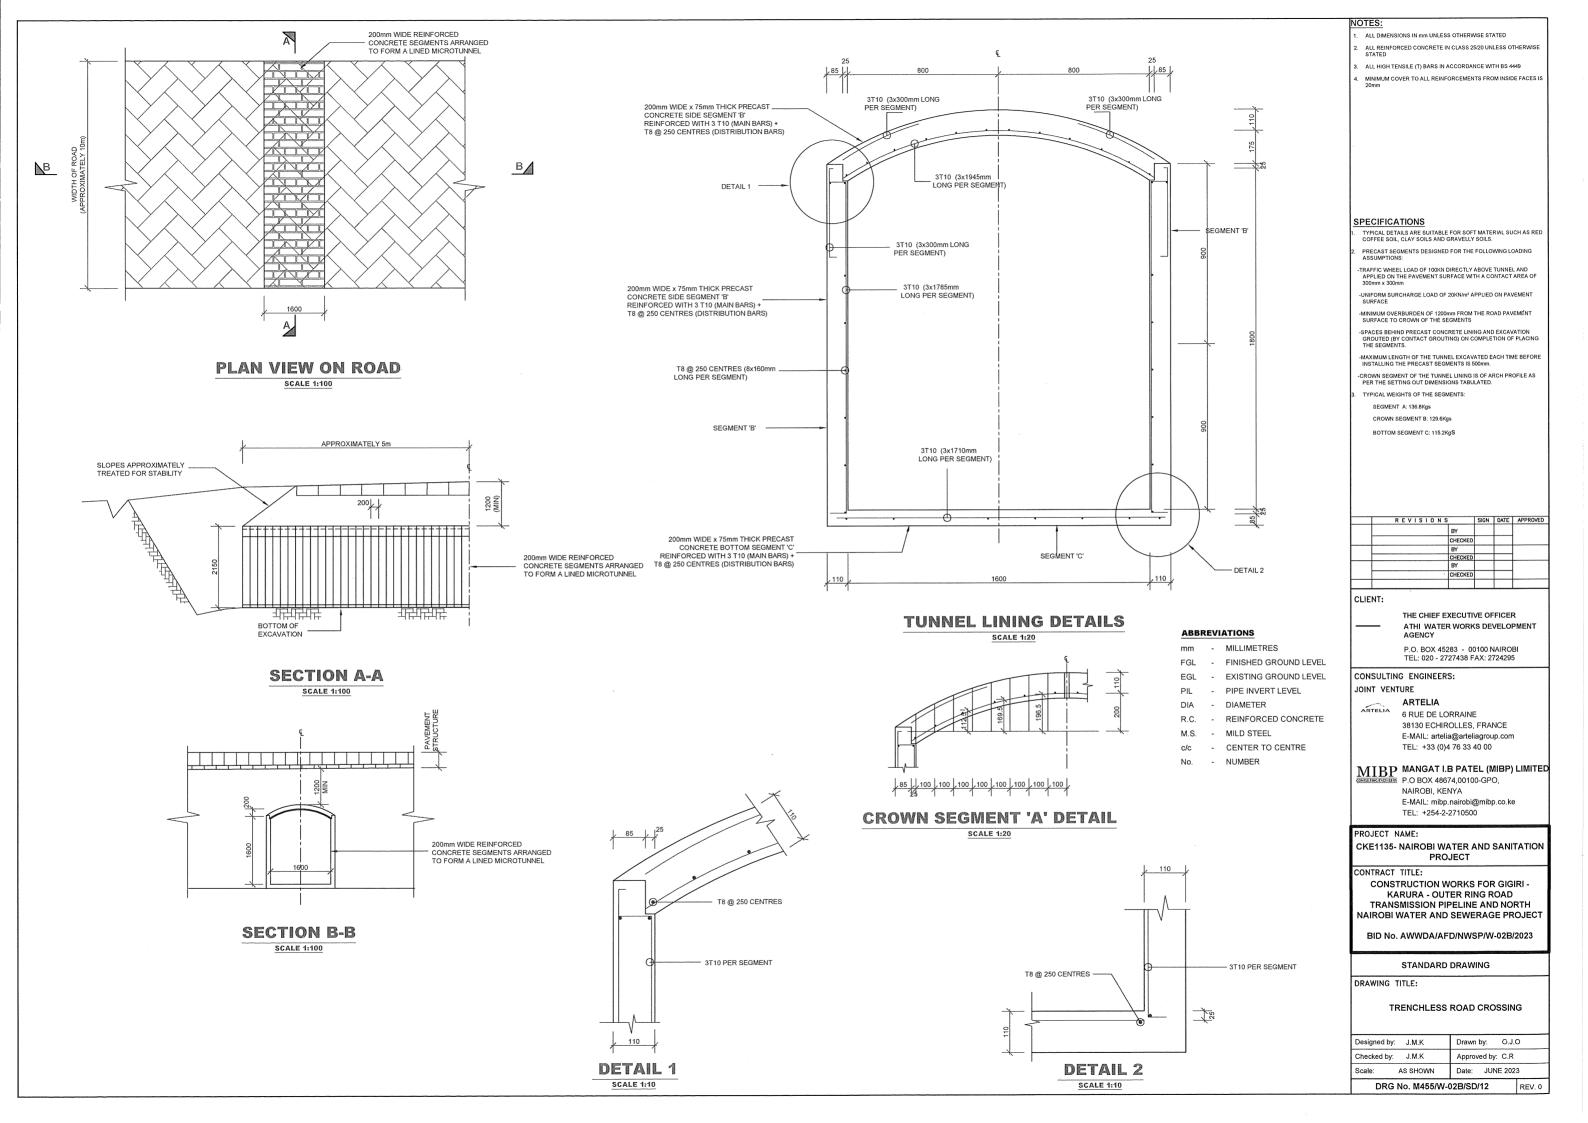
BID No. AWWDA/AFD/NWSP/W-02B/2023

### STANDARD DRAWING


### DRAWING TITLE:

PIPE TRENCH AND CONCRETE SURROUND

Designed	by: J.M.K	Drawn b	y: O.J.	0
Checked I	oy: J.M.K	Approved by: C.R		
Scale:	AS SHOWN	Date:	JUNE 202	3
DF	RG No. M455/W	-02B/SD/	11	REV. 0



### 1. BITUMINOUS CARRIAGEWAY

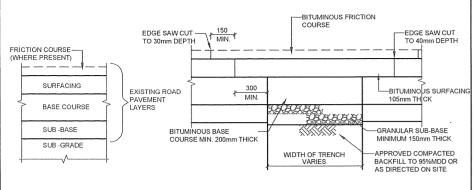

### EXISTING CONSTRUCTION (MAY VARY ON SITE)

### PERMANENT REINSTATEMENT

### NOTES:

- THE REINSTATEMENT SUB-BASE MATERIAL TO BE PUT BACK SHALL BE OF THE SAME THICKNESS AS
  THE ORIGINAL ADJOINING PAVEMENT SUBJECT TO A MINIMUM OF 150mm.
- THE REINSTATEMENT ROAD-BASE TO BE PUT BACK SHALL BE OF APPROVED BITUMINOUS
   MATERIAL AND OF THE SAME THICKNESS AS THE ADJOINING PAVEMENT SUBJECT TO A MINIMUM OF
   200mm
- THE APPROVED BITUMINOUS SURFACING LAYER TO BE PUT BACK SHALL BE 105mm THICK AND SHALL CONSIST OF A 65mm THICK BASE COURSE AND A 40mm THICK WEARING COURSE.
- 4. FRICTION COURSE MAY BE ABSENT IN MOST URBAN ROADS, BUT WHERE A FRICTION COURSE IS PRESENT IN THE ORIGINAL ROAD PAVEMENT, A FRICTION COURSE LAYER OF THE SAME THICKNESS SHALL BE PUT BACK.
- 5. MATERIAL SPECIFICATION SHALL BE IN ACCORDANCE WITH GENERAL SPECIFICATIONS.

A TYPICAL PAVEMENT SECTION CONSTRUCTION MAY CONSIST OF

FRICTION COURSE - 10mm NOMINAL SIZE FRICTION COURSE MATERIAL

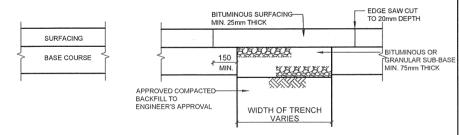
WEARING COURSE - 10 OR 20mm NOMINAL SIZE WEARING COURSE MATERIAL

BASE COURSE - 28 OR 37.5mm NOMINAL SIZE BASE COURSE MATERIAL
ROAD-BASE - 37.5mm NOMINAL SIZE ROAD-BASE COURSE MATERIAL

SUB-BASE - GRANULAR SUB-BASE

6. FOR LIMITS OF REINSTATEMENT REFER TO THE RULES IN MIDDLE COLUMN OF THIS DRAWING

### 2. BITUMINOUS FOOTWAY AND CYCLETRACK



### EXISTING CONSTRUCTION (MAY VARY ON SITE)

### PERMANENT REINSTATEMENT

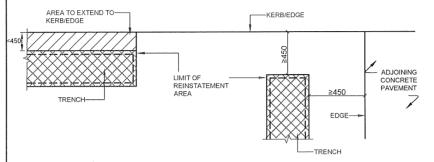
### NOTES:

- THE SUB-BASE TO BE PUT BACK SHALL BE OF EITHER APPROVED GRANULAR MATERIAL
   SPECIFICATIONS OR BITUMINOUS MATERIAL AND SHALL BE OF THE SAME THICKNESS AS THE
   ADJOINING ORIGINAL FOOTWAY OR CYCLETRACK SUBJECT TO A MINIMUM THICKNESS OF 75mm.
- THE SURFACING TO BE PUT BACK SHALL BE 10mm NOMINAL SIZE WEARING COURSE MATERIAL AND SHALL BE OF THE SAME THICKNESS AS THE ADJOINING ORIGINAL FOOTWAY OR CYCLETRACK SUBJECT TO A MINIMUM OF 25mm.
- 3. FOR LIMITS OF REINSTATEMENT REFER TO THE RULES IN MIDDLE COLUMN OF THIS DRAWING


# RULES TO DETERMINE THE LIMIT OF REINSTATEMENT IN BITUMINOUS CARRIAGEWAY, FOOTWAY AND CYCLETRACK

- A. CARRIAGEWAY CONSTRUCTED MORE THAN 5 YEARS AGO, CARRIAGEWAY RE-SURFACED


  MORE THAN 1 YEAR AGO AND FOOTWAY OR CYCLETRACK CONSTRUCTED MORE THAN 1 YEAR AGO
  - THE REINSTATED AREA (TRENCH WIDTH SHALL BE OF SUFFICIENT WIDTH TO ALLOW THE USE OF PROPER COMPACTING FOLIPMENT.
- 2. THE REINSTATED AREA SHALL EITHER
  - (a) BE AT AN EDGE (THE KERB LINE, THE BUILDING LINE OR ADJOINING CONCRETE PAVEMENT) OF THE BITUMINOUS PAVEMENT; OR
  - (b) BE AT A MINIMUM DISTANCE (MEASURED FROM ANY PART OF THE REINSTATEMENT AREA AT RIGHT ANGLE TO THE EDGE) OF 450mm FROM AN EDGE




- THE REINSTATEMENT AREA SHALL BE RECTANGULAR IN PLAN WITH THE SIDES EITHER PARALLEL
  OR PERPENDICULAR TO THE NEAREST EDGE OF THE BITUMINOUS PAVEMENT, STEPPED OR
  L-SHAPED REINSTATEMENT AREA IS PERMITTED ONLY IF-
- (a) THE REINSTATEMENT AREA RUNS ALONG THE LENGTH OF THE CARRIAGEWAY, FOOTWAY OR CYCLETRACK IN SUCH CASES
- THE LENGTH OF EACH STEP ALONG THE LENGTH OF THE CARRIAGEWAY, FOOTWAY OR
  CYCLETRACK IS NOT LESS THAN 20m EXCEPT AT LOCATION OF MANHOLES OR JUNCTION
  DOVES.
- THE LENGTH OF EACH STEP PERPENDICULAR TO THE LENGTH OF THE CARRIAGEWAY,
  FOOTWAY OR CYCLETRACK IS NOT LESS 300mm; OR
- (b) THE TRENCH GOES ROUND A ROAD JUNCTION, IN SUCH CASES A CHAMFER AT THE CORNER IS

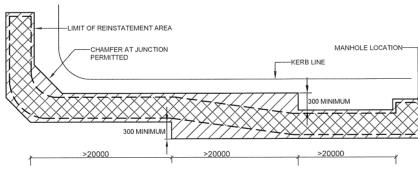


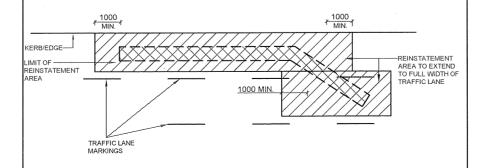- B. CARRIAGEWAY CONSTRUCTED WITHIN THE LAST 5 YEARS, CARRIAGEWAY RE-SURFACED WITHIN THE LAST 1 YEAR AND FOOTWAY OR CYCLETRACK CONSTRUCTED WITHIN THE LAST 1 YEAR
- IN ADDITION TO THE RULES MENTIONED IN A ABOVE, THE REINSTATEMENT AREA SHALL EXTEND TO THE
   FULL WIDTH OF THE TRAFFIC LANE(S) IN WHICH THE TRENCH IS SITUATED. ANY EXTENSION OF THE
   REINSTATEMENT AREA BEYOND THE MINIMUM LIMIT CAN BE DONE BY COLD MILLING AND RESURFACING
   THE WEARING COURSE WITHIN THE EXTENDED AREA.



### 3. PAVING SLAB/BLOCK CONSTRUCTION

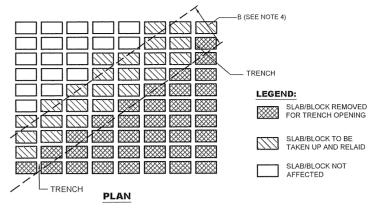

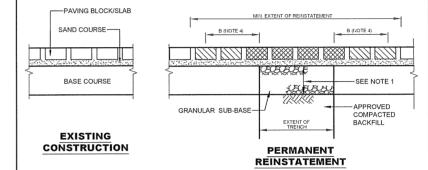

### NOTES:

- THE SUB-BASE TO BE PUT BACK SHALL BE OF GRANULAR MATERIAL TO GENERAL SPECIFICATIONS AND
   SHALL BE OF THE SAME THICKNESS AS THE ADJOINING PAVEMENT SUBJECT TO A MINIMUM OF 75mm IN
   FOOTWAY AND 150mm IN RUN-IN AND CARRIAGEWAY.
- 2. THE SAND COURSE TO BE PUT BACK SHALL EXCEED 20mm AND NOT EXCEED 30mm THICKNESS
- THE PAVING SLABS/BLOCKS SHALL BE OF THE SAME THICKNESS AS THE ADJOINING PAVEMENT SUBJECT TO A MINIMUM OF 60mm IN FOOTWAY AND 80mm IN CARRIAGEWAY OR RUN-IN.
- 4. ALL PAVING SLABS/BLOCKS WITHIN A DISTANCE OF B MILLIMETERS FROM THE SIDE OF A TRENCH OR DISTURBED AS A RESULT OF THE TRENCH WORKS SHALL BE TAKEN UP AND RELAID TOGETHER WITH THE OTHER SLABS/BLOCKS REMOVED FOR THE TRENCHING WORK. B SHALL BE AT LEAST 300mm OR TWICE THE LARGEST LATERAL DIMENSION OF THE PAVING SLABS/BLOCKS USED IN THE PAVING PATTERN (THE PATTERN MAY INVOLVE SLABS/BLOCKS OF A FEW DIFFERENT SIZES), WHICHEVER IS THE GREATER. IF NECESSARY, FURTHER SLABS/BLOCKS SHOULD BE LIFTED AND REINSTATED.
- THE PAVING SLABS/BLOCKS SHALL BE RELAID ACCORDING TO THE ORIGINAL PATTERN. ANY SLABS/BLOCKS DAMAGED OR LOST SHALL BE REPLACED.

### NOTES

ALL DIMENSIONS IN mm UNLESS OTHERWISE STATED

### ABBREVIATIONS:

mm - MILLIMETRES

FGL - FINISHED GROUND LEVE

EGL - EXISTING GROU DIA - DIAMETER

€ - CENTER LINE

### CLIENT:

THE CHIEF EXECUTIVE OFFICER
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AGENCY

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### PROJECT NAME:

CKE1135- NAIROBI WATER AND SANITATION PROJECT

TEL: +254-2-2710500

### CONTRACT TITLE:

CONSTRUCTION WORKS FOR GIGIRI -KARURA - OUTER RING ROAD TRANSMISSION PIPELINE AND NORTH NAIROBI WATER AND SEWERAGE PROJECT

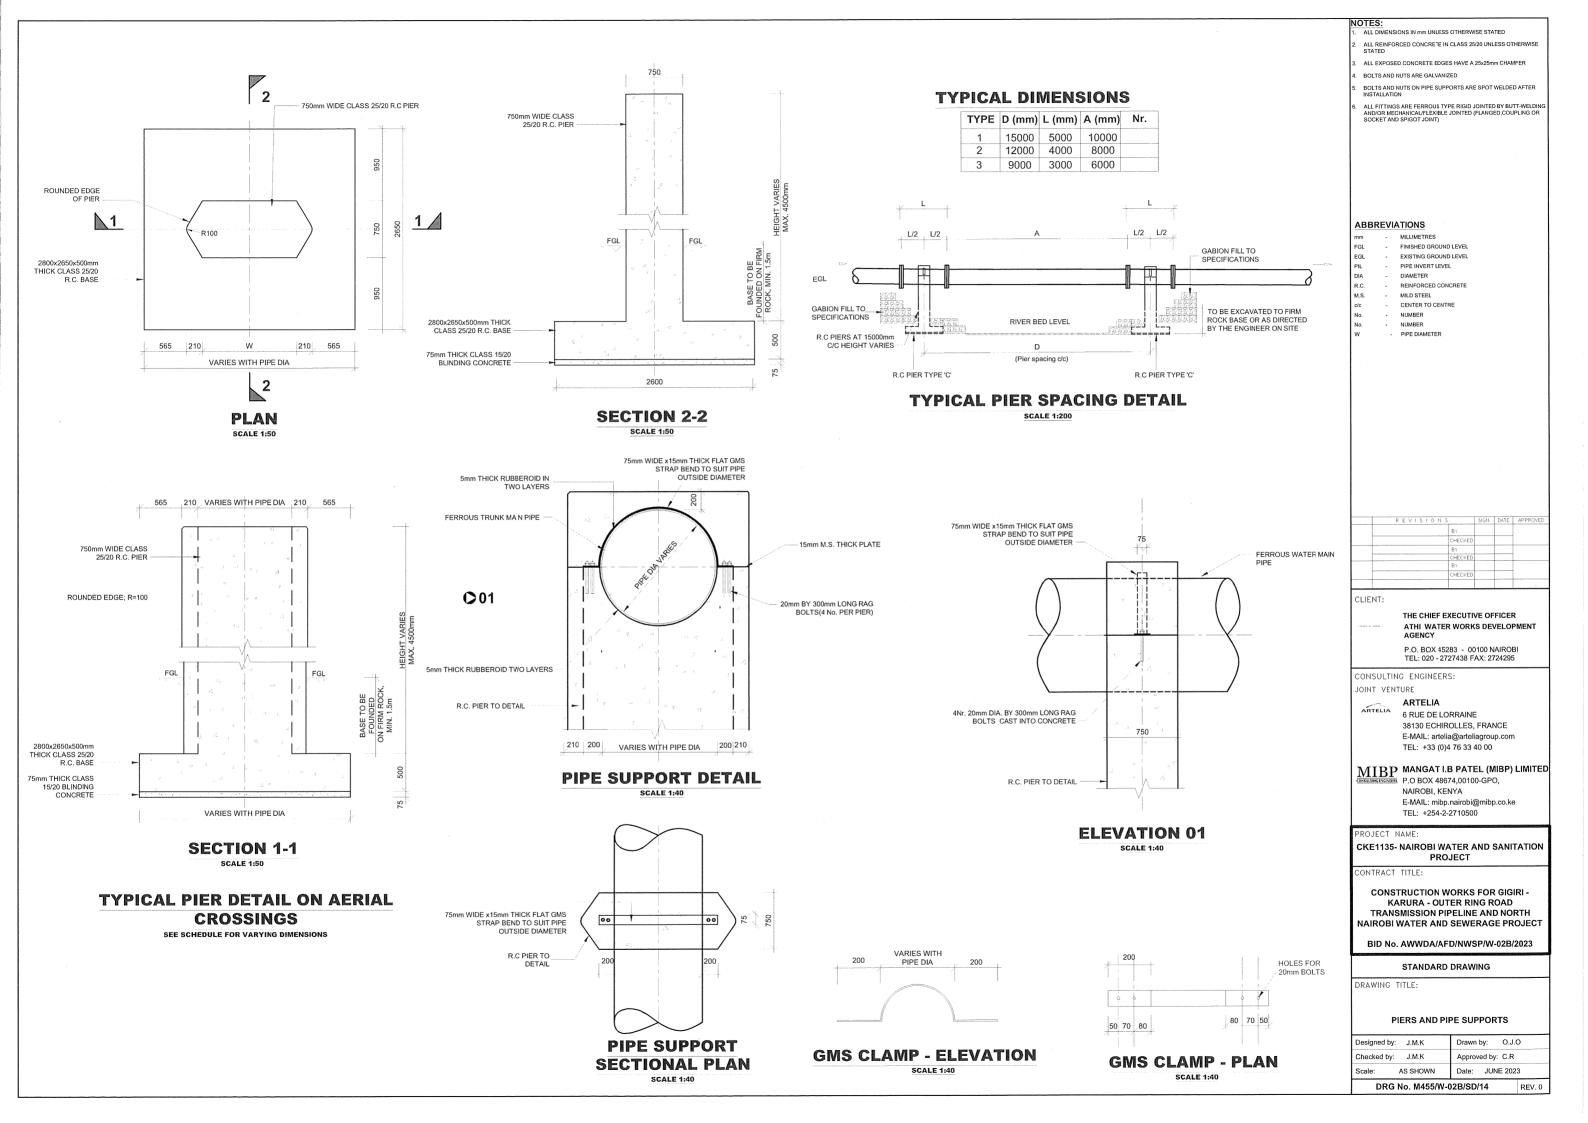
BID No. AWWDA/AFD/NWSP/W-02B/2023

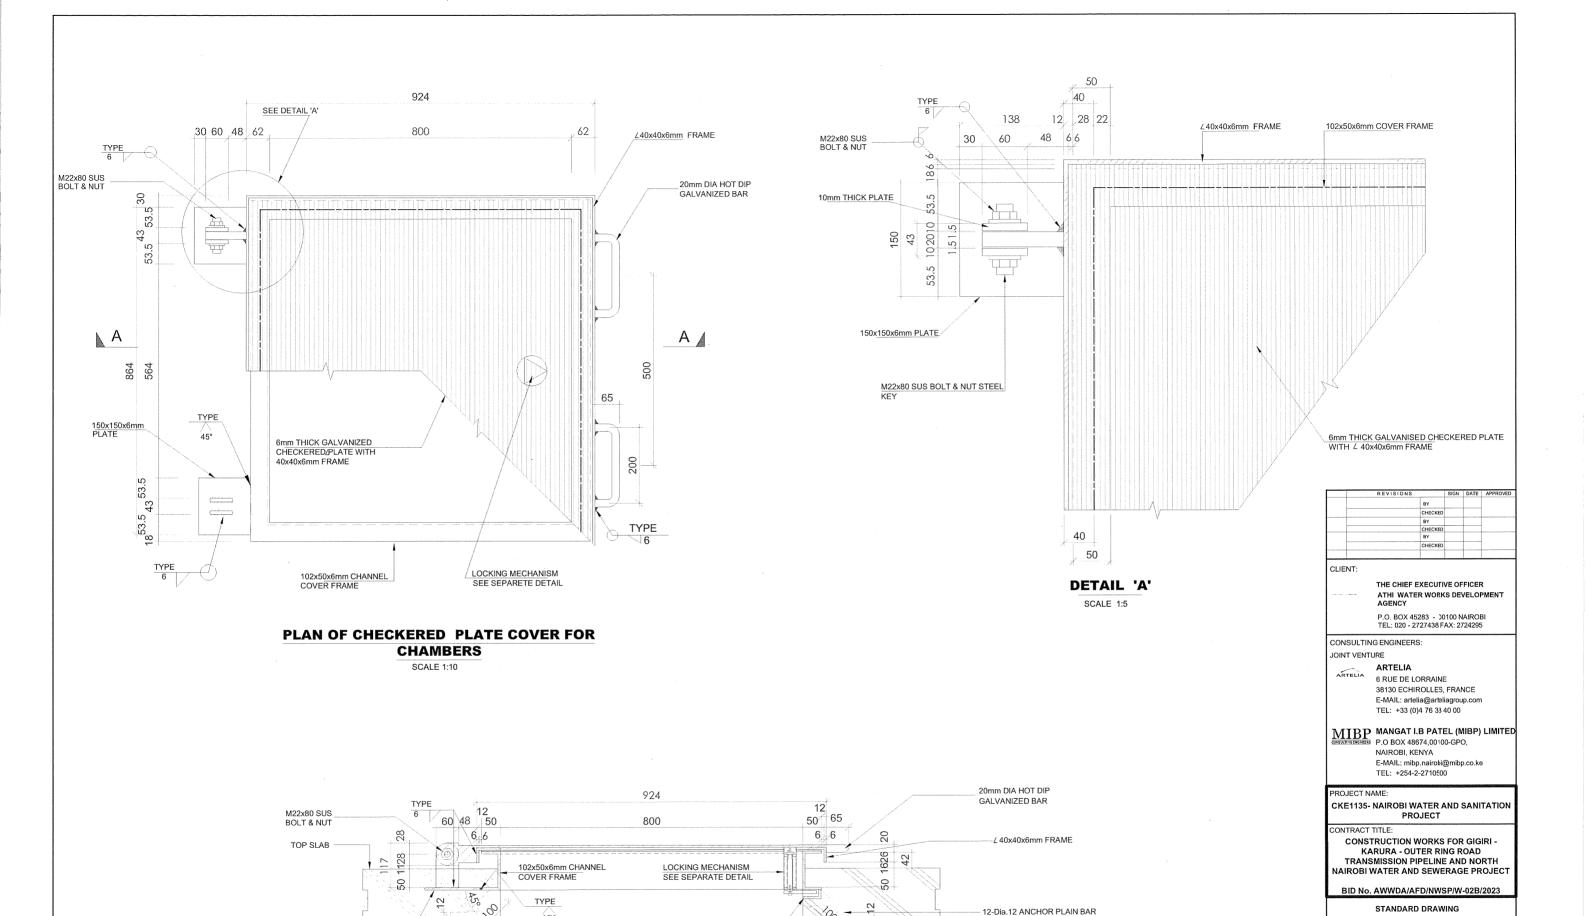
### STANDARD DRAWING

DRAWING TITLE:

### PERMANENT REINSTATEMENT OF PAVEMENTS

Designed by: J.M.K		Drawn by: O.J.O		
Checked I	by: J.M.K	Approved by: C.R		
Scale: AS SHOWN		Date: JUNE 2023		





45°

50

150x150x6mm PLATE

6mm THICK PLATE

SECTION A-A

DRAWING TITLE:

Designed by: J.M.K

Checked by: J.M.K

e: AS SHOWN Date: JUN DRG No. M455/W-02B/SD/15

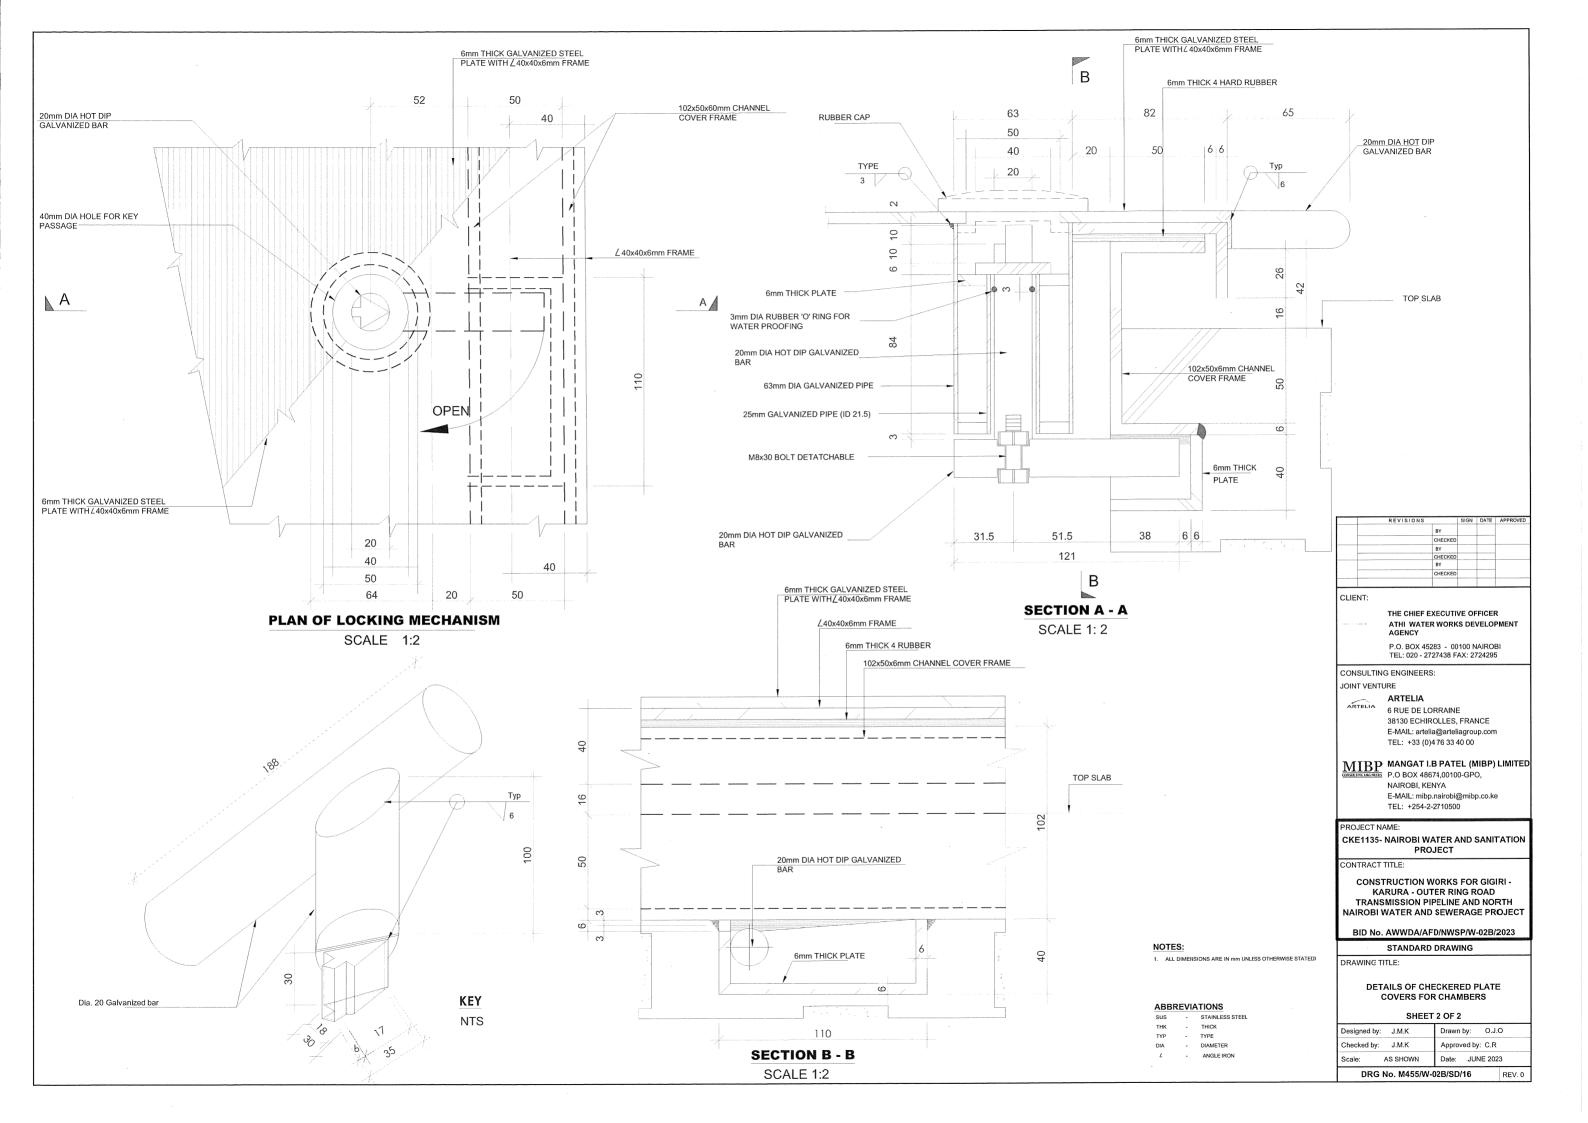
DETAILS OF CHECKERED PLATE COVERS FOR CHAMBERS

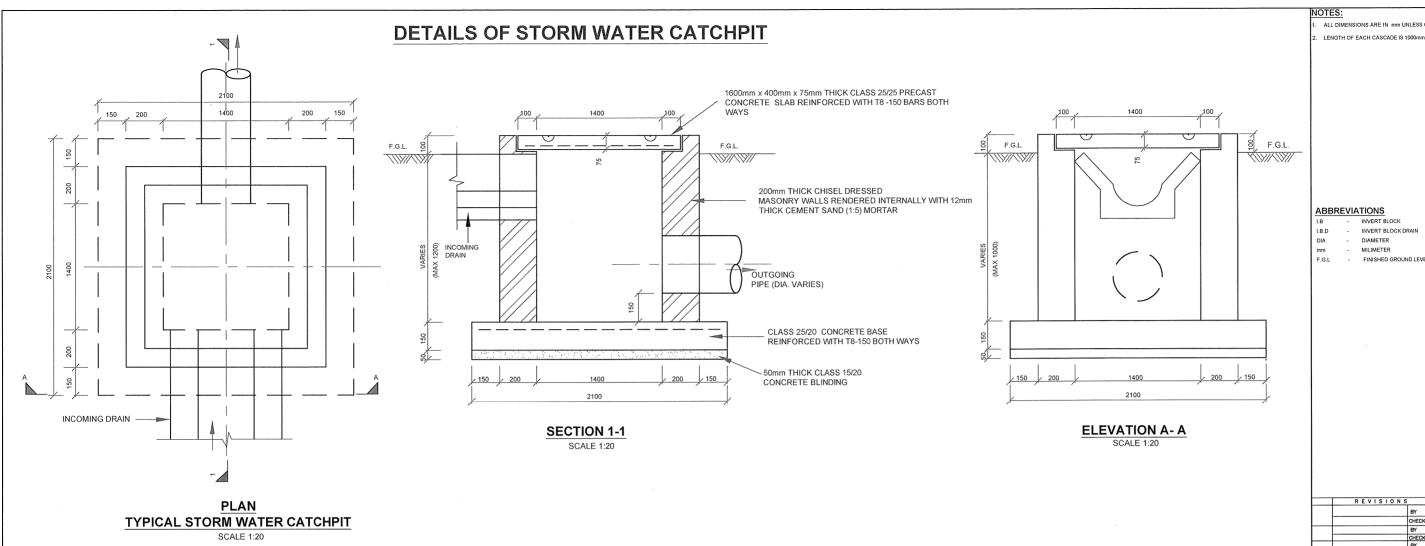
SHEET 1 OF 2

Drawn by: O.J.O

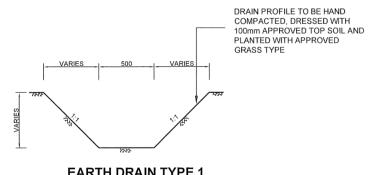
Approved by: C.R

Date: JUNE 2023











**EARTH DRAIN TYPE 1** 

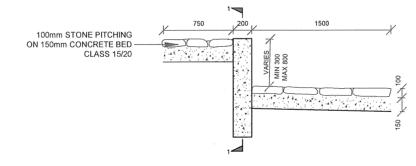


**SECTION SILL FOR DRAIN TYPE 1** 



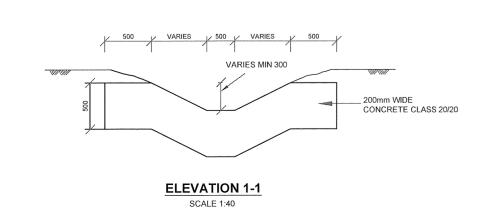

### **DETAILS OF DRAIN TYPE '2'** (STONE PITCHED DRAIN)

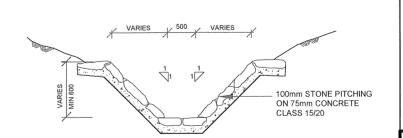

**DRAIN TYPE 2** (STONE PITCHED DRAIN)

ALL DIMENSIONS ARE IN mm LINLESS OTHERWISE STATED

INVERT BLOCK DRAIN

FINISHED GROUND LEVEL

### CLIENT:

THE CHIEF EXECUTIVE OFFICER

ATHI WATER WORKS DEVELOPMENT AGENCY

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### CONSULTING ENGINEERS:

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PROJECT NAME:

CKE1135- NAIROBI WATER AND SANITATION PROJECT

CONTRACT TITLE:

CONSTRUCTION WORKS FOR GIGIRI -KARURA - OUTER RING ROAD TRANSMISSION PIPELINE AND NORTH NAIROBI WATER AND SEWERAGE PROJECT

BID No. AWWDA/AFD/NWSP/W-02B/2023

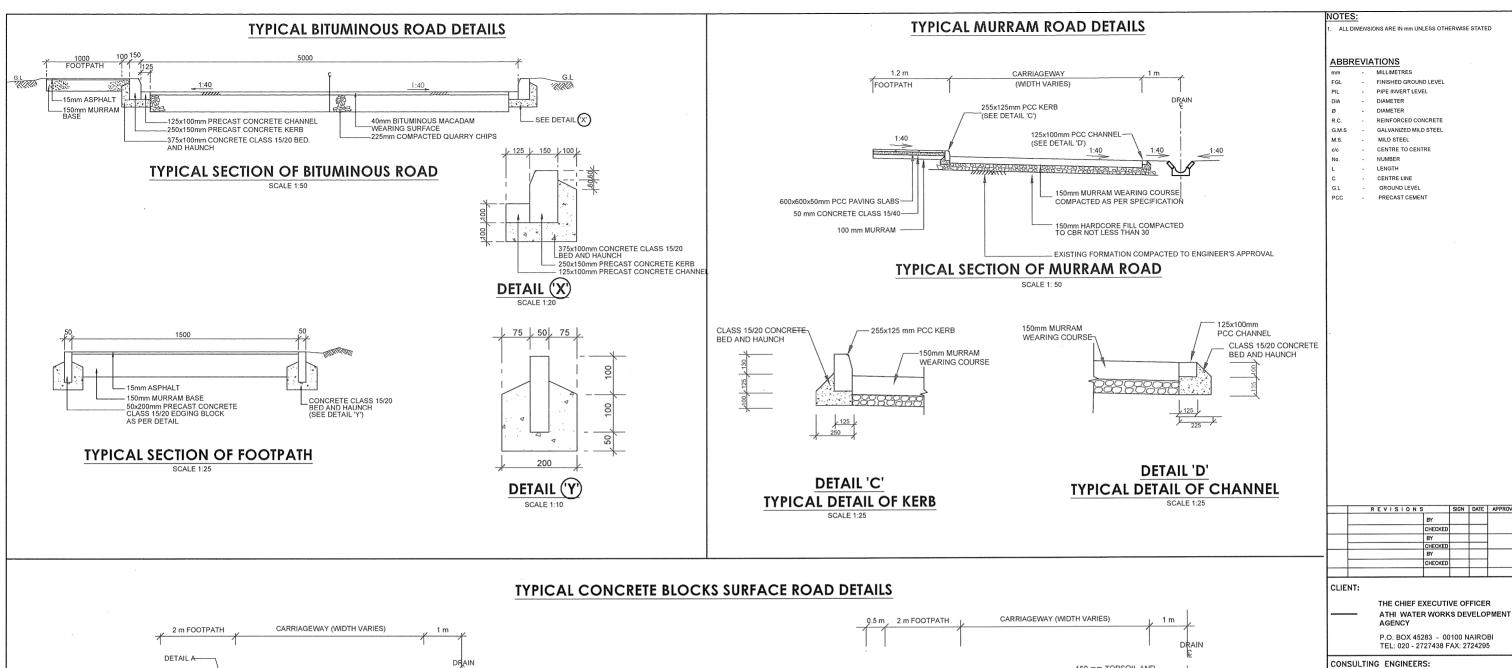
STANDARD DRAWING

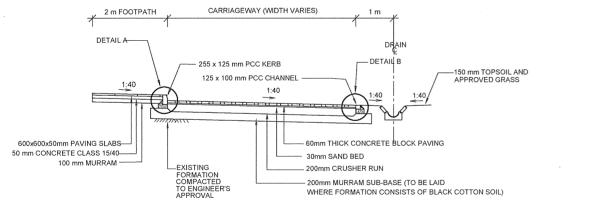
DRAWING TITLE:

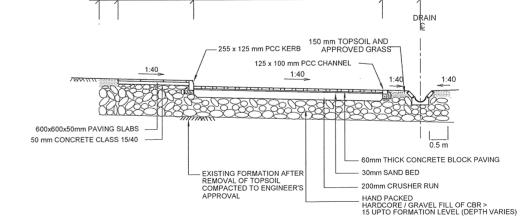
DETAILS OF STORMWATER CATCH PIT AND EARTH DRAINS

Designed b	y: J.M.K	Drawn by: O.J.O	
Checked by	y: J.M.K	Approved by: C.R	
Scale: AS SHOWN		Date:	JUNE 2023

DRG No. M455/W-02B/SD/17







### TYPICAL CROSS SECTION FOR CARRIAGEWAY IN CUT

DETAIL A

### TYPICAL CROSS SECTION FOR CARRIAGEWAY IN FILL

SCALE 1:100

# ASS 15/20 CONCRETE D AND HAUNCH 255 x 125 mm PCC KERB 125 x 100 mm PCC CHANNEL CONCRETE CLASS 15/20 BED AND HAUNCH 30mm SAND BED 200mm CRUSHER RUN 200mm MURRAM SUB-BASE (TO BE LAID WHERE FORMATION CONSISTS OF BLACK COTTON SOIL) 225 200

DETAIL OF KERB

DETAIL OF CHANNEL

	`	
25		TYPICAL ROAD CROSS
200	<b> </b>	SECTION DETAILS

Designed	by: J.M.K	Drawn by: 0	O.J.O	
Checked by: J.M.K		Approved by: C.R		
Scale: AS SHOWN		Date: JUNE	2023	
DF	RG No. M455/W	-02B/SD/18	REV. 0	

IOINT VENTURE

PROJECT NAME:

ONTRACT TITLE:

DRAWING TITLE:

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CKE1135- NAIROBI WATER AND SANITATION PROJECT

CONSTRUCTION WORKS FOR GIGIRI -

KARURA - OUTER RING ROAD

TRANSMISSION PIPELINE AND NORTH NAIROBI WATER AND SEWERAGE PROJECT

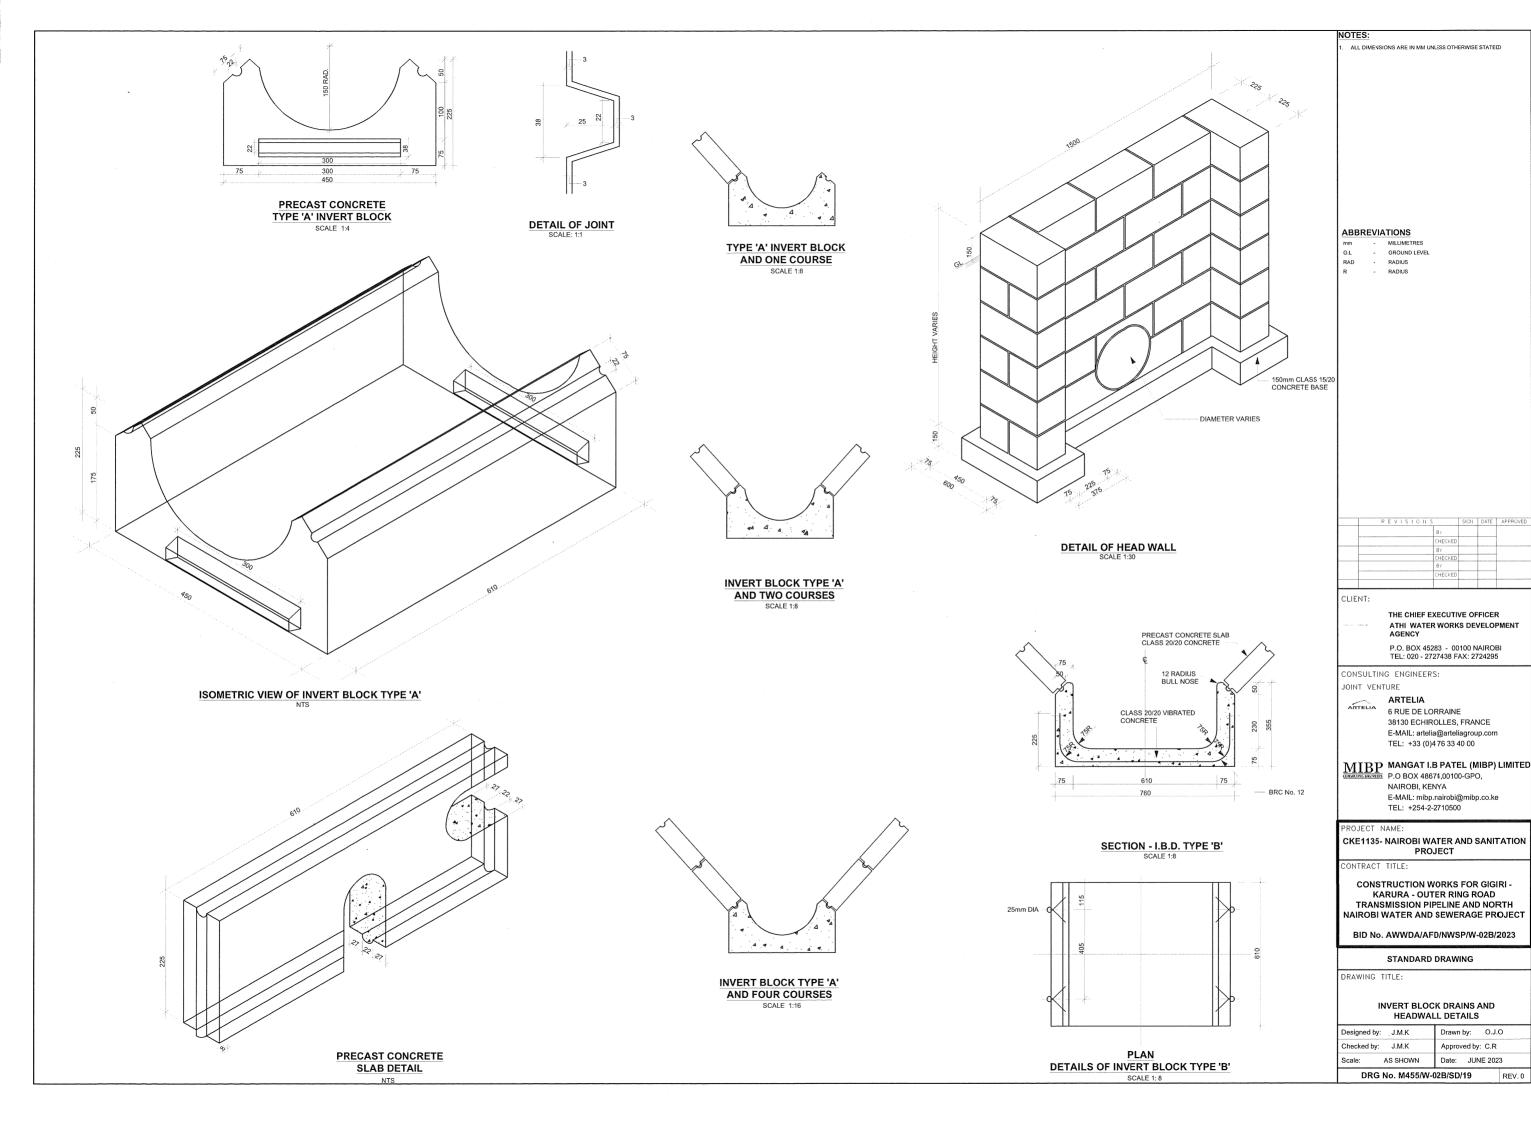
BID No. AWWDA/AFD/NWSP/W-02B/2023

STANDARD DRAWING

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REV. 0