

ATHI WATER WORKS DEVELOPMENT AGENCY




NARSIP PHASE II-LOT 5- CONSTRUCTIONN OF NAIROBI INFORMAL SETTLEMENTS WATER AND SANITATION INTENSIFICATION WORKS.

TENDER DRAWINGS

MARCH 2022

CHIEF EXECUTIVE OFFICER. Athi Water Works Development Agency P.O. Box 45283-00100,Nairobi Athi Water Plaza Muthaiga North Road. Off Kiambu Road.



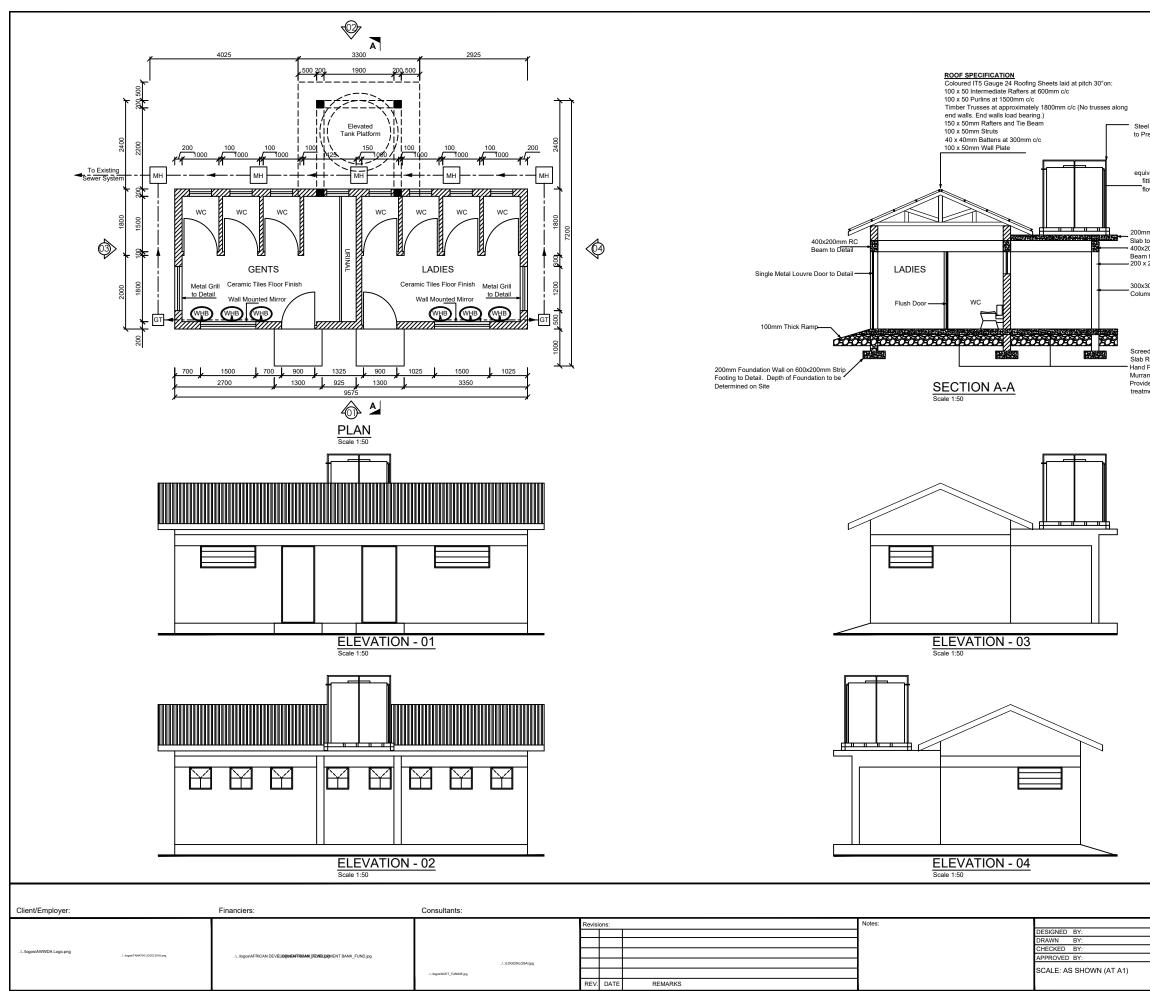

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. ALL DIMENSIONS ARE IN MILLIMETERS UNLESS OTHERWISE STATED.

 Steel Frame Sorrounding the Tank to Prevent From Theft to Detail


5,000 Ltr capacity Water tank 'Roto' or approved equivalent to Manufacturer's Specification. Plumbing & fittings to detail (to include Inlet, Outlet, Scour, Over flow pipeworks of 25mm dia complete with 3rr Gate Valves, 3rr Unions, 1nr Ball Valve)

200mmThick RC Slab to Detail • 400x200mm RC Beam to Detail • 200 x 200mm RC Lintel to detail


300x300mm RC Column to Detail

Screed Floor Finish on 150mm Thick Floor Slab Reinforced with BRC A142, 300mm thick Hand Packed Well Compacted hardcore with Murram Blinding on Compact Earth. DPC to be Provided under all Ground Floor walls after treatment of soil with Anti Termite.

Project:		CONSTRUCTION OF NAIROBI INFORMAL SETTLEMENTS NITATION INTENSIFICATION WORKS.					
Drawing Title:							
STANDARD DRAWING							
PROPOSED ABLUTION BLOCK - PLAN, ELEVATIONS AND SECTION							
Date: MARCH 2022 Drg. No. KTSWSSP/MSP/STD/ABLUTION BLOCK/01							

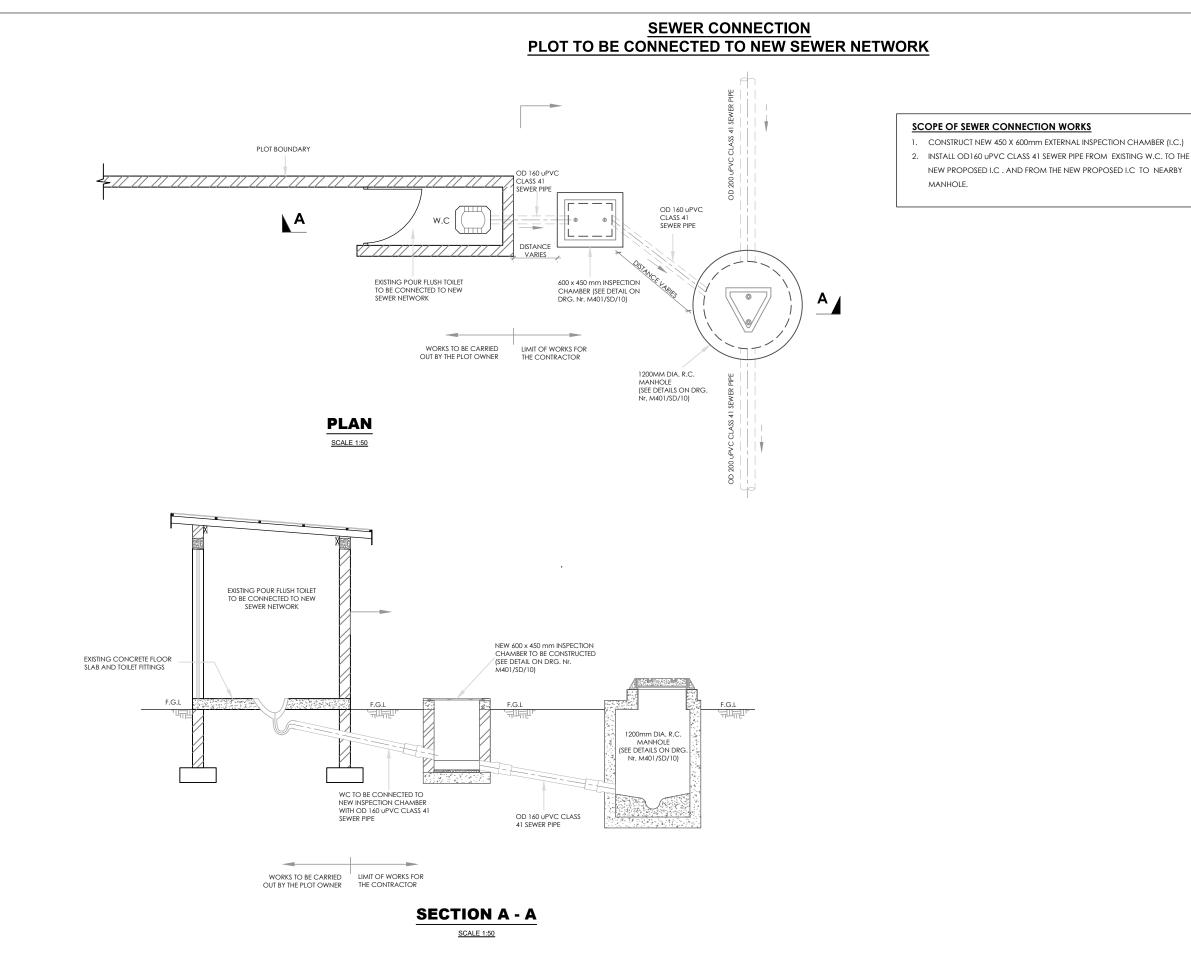

NOTES: ALL DIMENSIONS ARE IN MM UNLESS OTHERWISE STATED DETAILS SHOWN ON THIS DRAWING ARE TYPICAL. EXACT ARRANGEMENT AND DIMENSIONS OF THE COMPONENTS TO BE DETERMINED BY THE ENGINEER ON A CASE-BY-CASE BASIS ON SITE ABBREVIATIONS - MILLIMETERS mm OD - OUTSIDE DIAMETER F.G.L - FINISHED GROUND LEVEL DIA. - DIAMETER uPVC - UNPLASTICISED POLYVINYL CHLORIDE R.C - REINFORCED CONCRETE W.C - WATER CLOSET I.C - INSPECTION CHAMBER F.F.L - FINISHED FLOOR LEVEL M.H - MANHOLE AS-BUILT DRAWINGS CLIENT: CHIEF EXECUTIVE OFFICER ATHI WATER W RKS ATHI WATER WORKS DEVELOPMENT AGENCY P.O BOX 45283 - 00100 NAIROBI TEL: 020 - 2727438 FAX: 2724295 PROJECT TITLE: NAIROBI RIVERS BASIN REHABILITATION PROGRAM NARSIP-2 CONTRACT No. AWWDA/NARSIP II/W-04/2021 CONSTRUCTION OF EAST AND WEST OF NAIROBI RETICULATION SEWERS STANDARD DRAWINGS DRAWING TITLE: TYPICAL SEWER CONNECTION DETAILS Designed by: Drawn by: Checked by: Approved by: Scale: Date: DRG No.

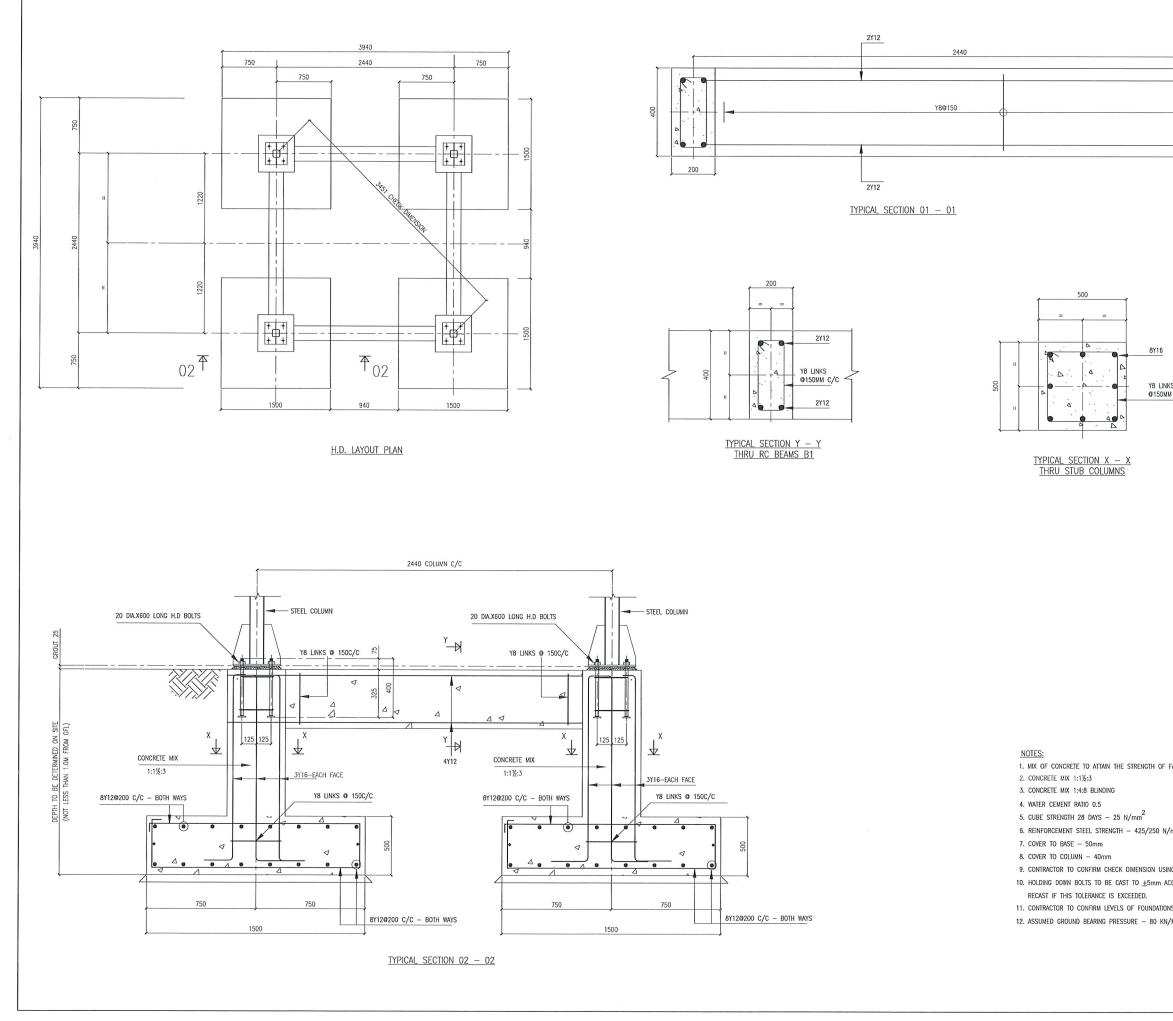



	 NOTES READ THE DRAWING IN CONJUCTION WITH RELEVANT R.C. DRAWINGS. ALL DIMENSIONS ARE IN MILLIMETERS UNLESS OTHERWISE STATED. ALL LEVELS ARE IN METERS ABOVE SEA LEVEL. ALL PIPEWORK ARE DUCTILE IRON TO NP 10 WITH NP 16 FLAKGES ALL CONCRETE SHALL BE CLASS C30 UNLESS OTHERWISE STATED ALL VALVES TO BE SUPPLIED WITH EXTENSION SPINDLE. MIN CONCRETE COVER OF 40 mm TO THE MAIN STEEL TO BE MANITAINED. SAFE BEARING CAPACITY TAKEN AS OF 150KN/M2, ALL FOUNDATIONS TO BE TAKEN DOWN TO A SUITABLE ROCK. MAXIMUM AGGREGATE SIZE FOR CONCRETE IS 20mm. ALL REINFORCEMENT TO BE INSPECTED BY THE ENGINEER BEFORE CONCRETING.
	PROJECT TITLE: PROPOSED 24M ³ PRESSED STEEL TANK ON 18M TOWER.
c/c su 25 N/mm ² street tape measure. Suracy and should be	DRAWING TITLE RC FOUNDATION & H.D. BOLTS LAYOUT DETAILS.
	CLIENT
	ATHI WATER SERVICES BOARD. KAMBITI CHIEFS CAMP.
Fcu 25 N/mm ²	
′mm ²	CONTRACTOR INSTA PUMPS ENGINEERING LIMITED
NG STEEL TAPE MEASURE. CCURACY AND SHOULD BE	P.O. Box 33248-00600 NAIROBI, KENYA
NS. 2	SCALE: 1:40 NAME SIGNATURE DATE Designed
	DRG No. 01

75Ø NB INLET N/S 4 mm PLATE. 4 mm PLATE. 4 mm PLATE. 4 mm PLATE. 1000 2000 4 mm PLATE. 1 mm PLATE. 4 mm PLATE. 4 mm PLATE. LEVEL 1000 75Ø NB 75ØNB OUTLET WASH-OUT 1000 1000 1000 4000

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SIDE ELEVATION



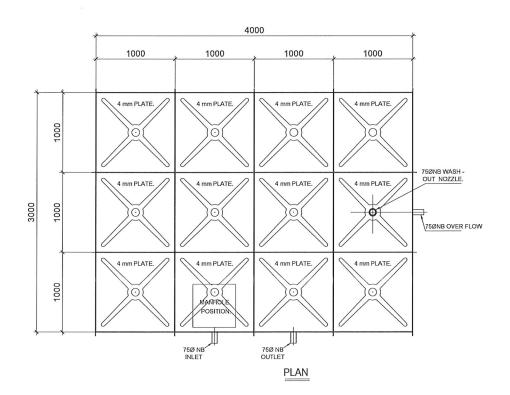
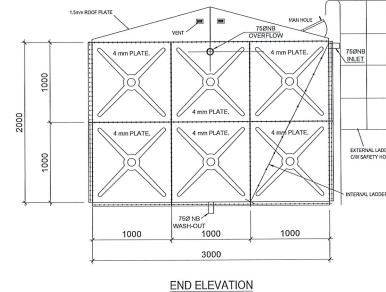
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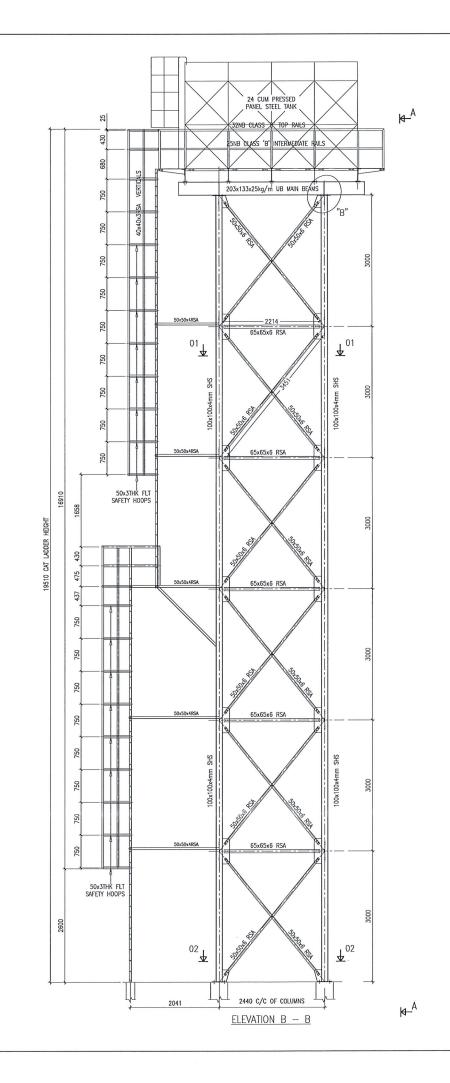
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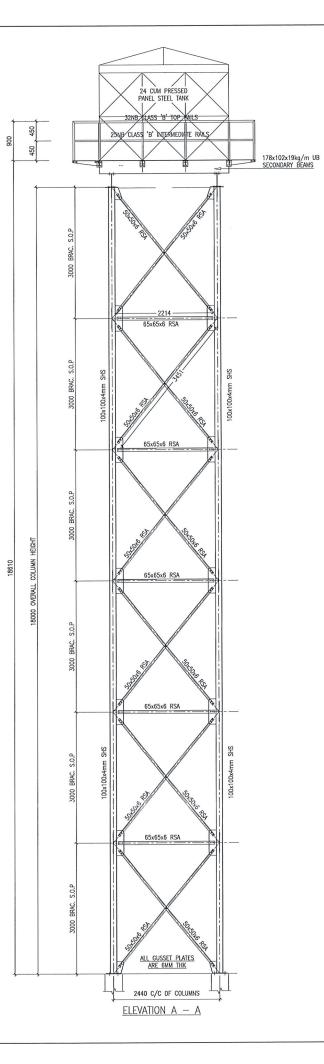
OVERFLOW	75MMØ NB
OUTLET	75MMØ NB
WASHOUT	75MMØ NB
INLET	75MMØ NB


GENERAL NOTES:

- ALL STRUCTURAL STEELWORK TO BE GRADE 43C.
 STEELWORK TO BE WIRE BRUSHED PRIOR TO
- FINISHING APPLICATION.
- 3) INSIDE TANK:ONE COAT OF PRIMER & TWO COATS OF NON TOXIC BITUMINOUS PAINT OUTSIDE TANK:ONE COAT OF PRIMER & ONE COAT OF SILVER ALUMINIUM PAINT.
- 4) ALL SHOP WELDS TO BE 6MM FILLET WELDS
- UNLESS OTHERWISE NOTED.
- 5) ALL SECTION SIZES ARE AS SPECIFIED ON
- DRAWING UNLESS OTHERWISE NOTED. 6) BOLTS ARE GALVANIZED GRADE 8.8.

NOTES Submits IN COLLCION WITH RELEWAT R.C. GRAINSS, ALL DIRESSONS ACE IN MILLINETES UNLESS OTHERNSE STATED. ALL DECISIONS ACE IN MILLINETES UNLESS OTHERNSE STATED. ALL CONCRETE SHALL BE CASE DOD VIDES OTHERNSE STATED ALL CONCRETE COOR OF 40 mm TO THE MAIN STRELT D BE MINITARED. SUBJECT TITLE PROJECT TITLE CONTRETING. SUBMARY AND A SUBJECT D BE INSPECTED BY THE INSIDIET BEFORE CONTRETING. SUBMARY AND A SUBJECT D BE INSPECTED BY THE INSIDIET BEFORE CONTRETING. SUBMARY AND A SUBJECT D BE INSPECTED BY THE INSIDIET BEFORE CONTRETING. SUBMARY AND A SUBJECT D BE INSPECTED BY THE INSIDE BEFORE CONTRETING. SUBJECT TITLE PROJECT TITLE PROJ	
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PROJECT TITLE PROPOSED 24M ³ PRESSED STEEL TANK ON 18M TOWER. DRAWING TITLE PANEL DETAILS CLIENT ATHI WATER SERVICES BOARD. KAMBITI CHIEFS CAMP. CONTRACTOR ENGINEERING LIMITED P.O. Box 33248-00600 NAIROBI, KENYA SCALE: 1:50 Designed Intel Dravin Intel Dravind Intel	 SAFE BEARING CAPACITY TAKEN AS OF 150KN/M2, ALL FOUNDATIONS TO BE TAKEN DOWN TO A SUITABLE ROCK. MAXIMUM AGGREGATE SIZE FOR CONCRETE IS 20mm. ALL REINFORCEMENT TO BE INSPECTED BY THE ENGINEER BEFORE
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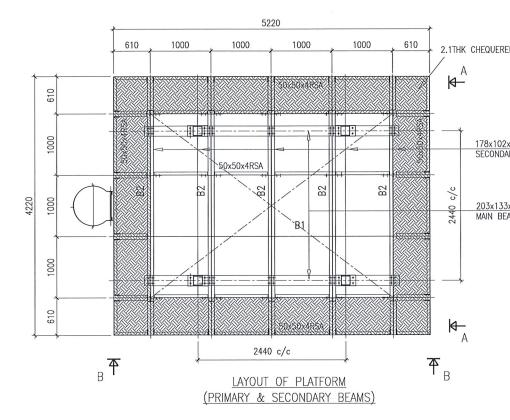



<u>TYPICAL CONNECTION</u> <u>DETAIL AT "A"</u>


GENERAL NOTES:

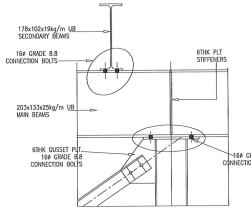 ALL STRUCTURAL STEELWORK TO BE GRADE 43C.
 STEELWORK TO BE WIRE BRUSHED PRIOR TO PAINT APPLICATION 3) APPLY ONE COAT OF GREY OXIDE PRIMER.
 APPLY ONE COAT OF SILVER ALUMINIUM PAINT.
 ALL SHOP WELDS TO BE 6MM FILLET WELDS U.O.N.
 BOLTS ARE CALVANIZED GRADE 4.6. & GRADE 8.8
 ALL SECTION SIZES TO BE AS SPECIFIED ON DRAWING.
 THIS DRAWING TO BE READ IN CONJUNCTION WITH ALL OTHER

	NOTES 1. READ THE DRAWING IN CONJUCTION WITH RELEVANT R.C. 2. DRAWINGS. ALL DIMENSIONS ARE IN MILLIMETERS UNLESS OTHERWISE STATED. 3. ALL LEVELS ARE IN METERS ABOVE SEA LEVEL. 4. ALL PIPEWORK ARE DUCTILE IRON TO NP 10 WITH NP 16 FLANGES 5. ALL CONCRETE SHALL BE CLASS C30 UNLESS OTHERWISE STATED 6. ALL VALVES TO BE SUPPLIED WITH EXTENSION SPINDLE.
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RADE 8.8 DN BOLTS	
юн.	PROJECT TITLE: PROPOSED 24M ³ PRESSED STEEL TANK ON 18M TOWER.
r relevant drawings.	DRAWING TITLE ELEVATION DETAILS
	<u>CLIENT</u> ATHI WATER SERVICES BOARD. KAMBITI CHIEFS CAMP.
	CONTRACTOR INSTA PUMPS ENGINEERRING LIMITED P.O. Box 33248-00600 NAIROBI, KENYA
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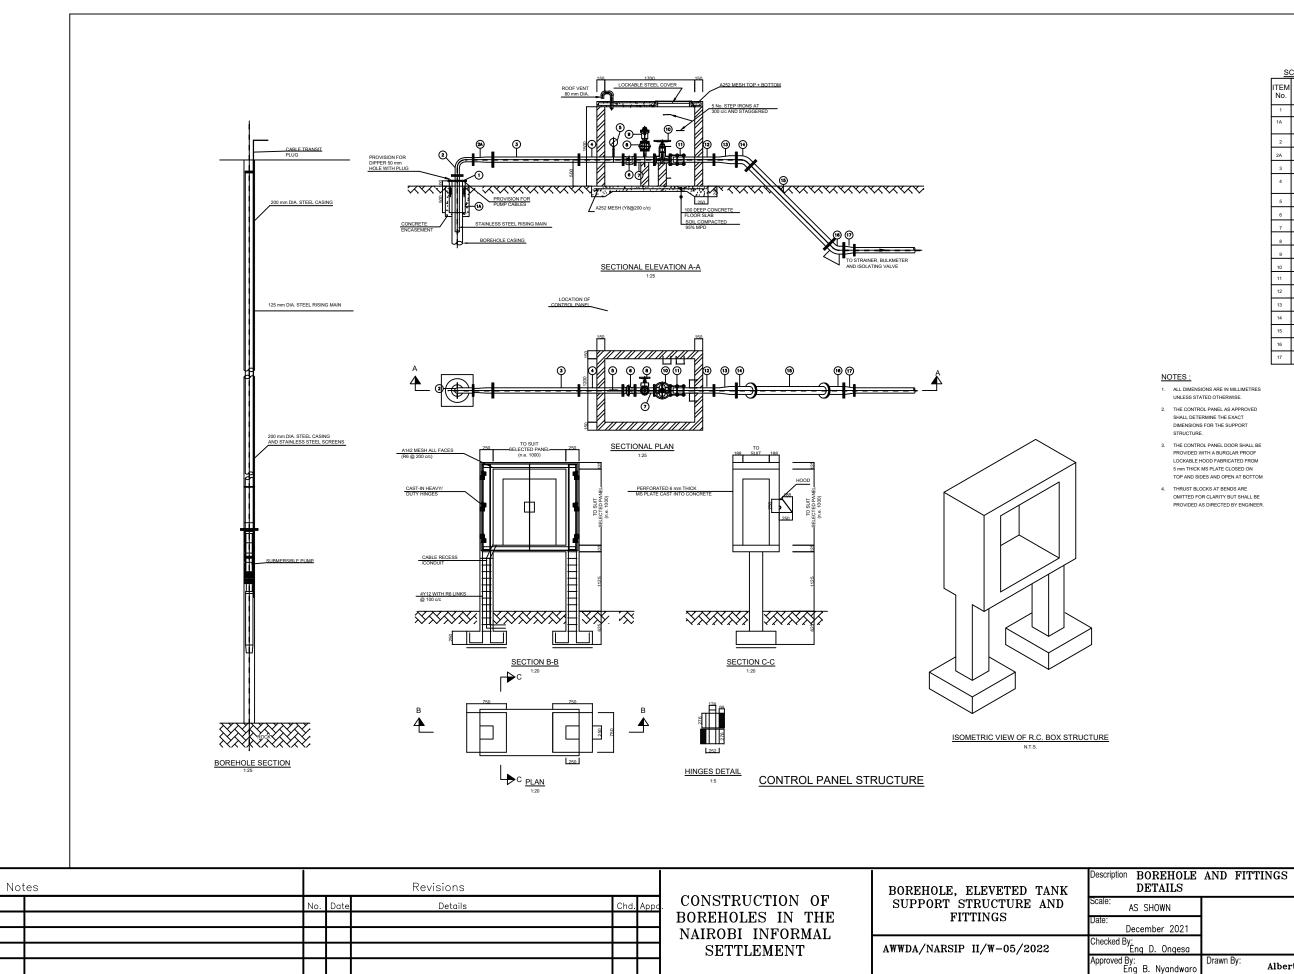


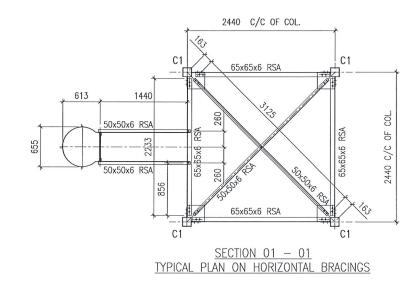

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	 SAFE BEARING CAPACITY TAKEN AS OF 150KN/M2, ALL FOUNDATIONS TO BE TAKEN DOWN TO A SUITABLE ROCK.
101 / 115	 ALL FOUNDATIONS TO BE TAKEN DUINT TO A SUITABLE NOR. MAXIMUM AGGREGATE SIZE FOR CONCRETE IS 20mm.
RY BEAMS	11. ALL REINFORCEMENT TO BE INSPECTED BY THE ENGINEER BEFORE
	CONCRETING.
<u>x25kg/m_U</u> B AMS	
	PROJECT TITLE:
	PROPOSED 24M ³ PRESSED STEEL TANK ON 18M TOWER.
19kg/m_UB Y BEAMS 25kg/m_UB	
	PLATFORM DETAILS
19kg/m UB Y BEAMS 25kg/m UB	ATHI WATER SERVICES BOARD.
	KAMBITI CHIEFS CAMP.
	CONTRACTOR
	INSTA PUMPS ENGINEERING LIMITED
	P.O. Box 33248-00600
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SCHEDULE OF PIPEWORK & FITTINGS PER BOREHOLE						
ITEM No.	DESCRIPTION	No.				
1	10 mm THICK WELL HEAD PLATE BOLTED TO CASING FLANGE	1				
1A	MILD STEEL CASING CAST INTO CONCRETE WITH FLANGE FOR WELLHEAD PLATE	1				
2	DOUBLE FLANGED 90° BEND	1				
2A	DOUBLE FLANGED REDUCER	1				
3	DOUBLE FLANGED PIPE PIECE, 2000 mm LONG	1				
4	DOUBLE FLANGED PIPE PIECE, 800 mm LONG WITH PROVISION FOR PRESSURE GAUGE	1				
5	PRESSURE GAUGE	1				
6	DOUBLE FLANGED NON-RETURN VALVE	1				
7	DOUBLE FLANGED TEE (WITH THREADED ADAPTOR FOR DN 50)	1				
8	DOUBLE FLANGED (OR THREADED DN 50) SLUICE VALVE	1				
9	ANTI SHOCK ANTI SURGE AIR VALVE	1				
10	DOUBLE FLANGED SLUICE VALVE	1				
11	RESTRAINED DISMANTLING JOINT	1				
12	SINGLE FLANGED PIPE PIECE 800 mm LONG	1				
13	DOUBLE FLANGED REDUCER	1				
14	DOUBLE FLANGED 45° BEND	1				
15	DOUBLE FLANGED PIPE PIECE 2100 mm LONG	1				
16	DOUBLE FLANGED 45° BEND	1				
17	DOUBLE FLANGED REDUCER	1				

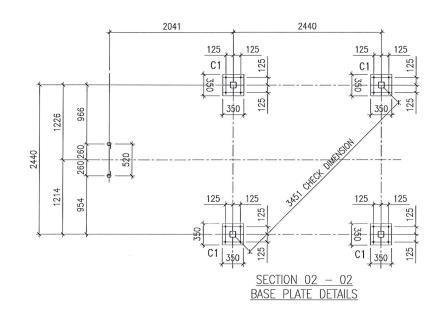ALL DIMENSIONS ARE IN MILLIMETRES UNLESS STATED OTHERWISE.

2. THE CONTROL PANEL AS APPROVE SHALL DETERMINE THE EXACT DIMENSIONS FOR THE SUPPORT

5 moors. 1. THE CONTROL PANEL DOOR SHALL BE PROVIDED WITH A BURGLAR PROOF LOCKABLE HOOD FABRICATED FROM 5 mm THICK MS PLATE CLOSED ON TOP AND SIDES AND OPEN AT BOTTOM

THRUST BLOCKS AT BENDS ARE OMITTED FOR CLARITY BUT SHALL BE PROVIDED AS DIRECTED BY ENGINEER





ATHI WATER WORKS DEVELOPMENT AGENCY


Drawn By:

Albert Ocharo

Drawing No: AWWDA/ACPEU/BH/01

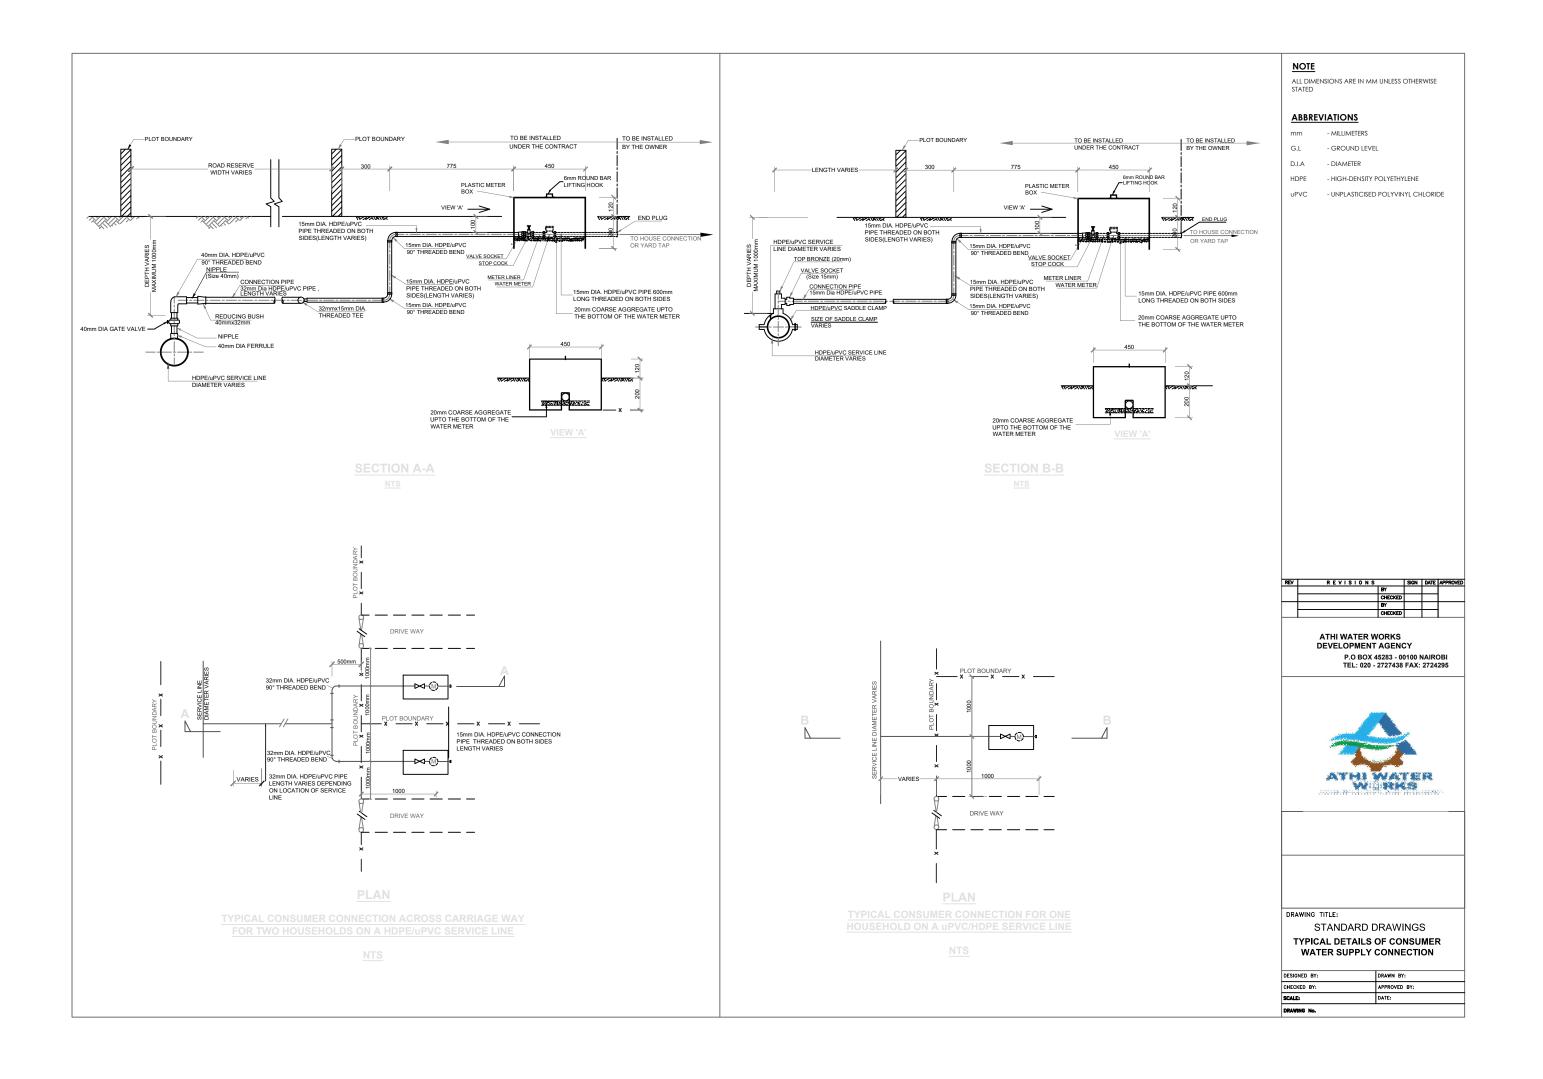


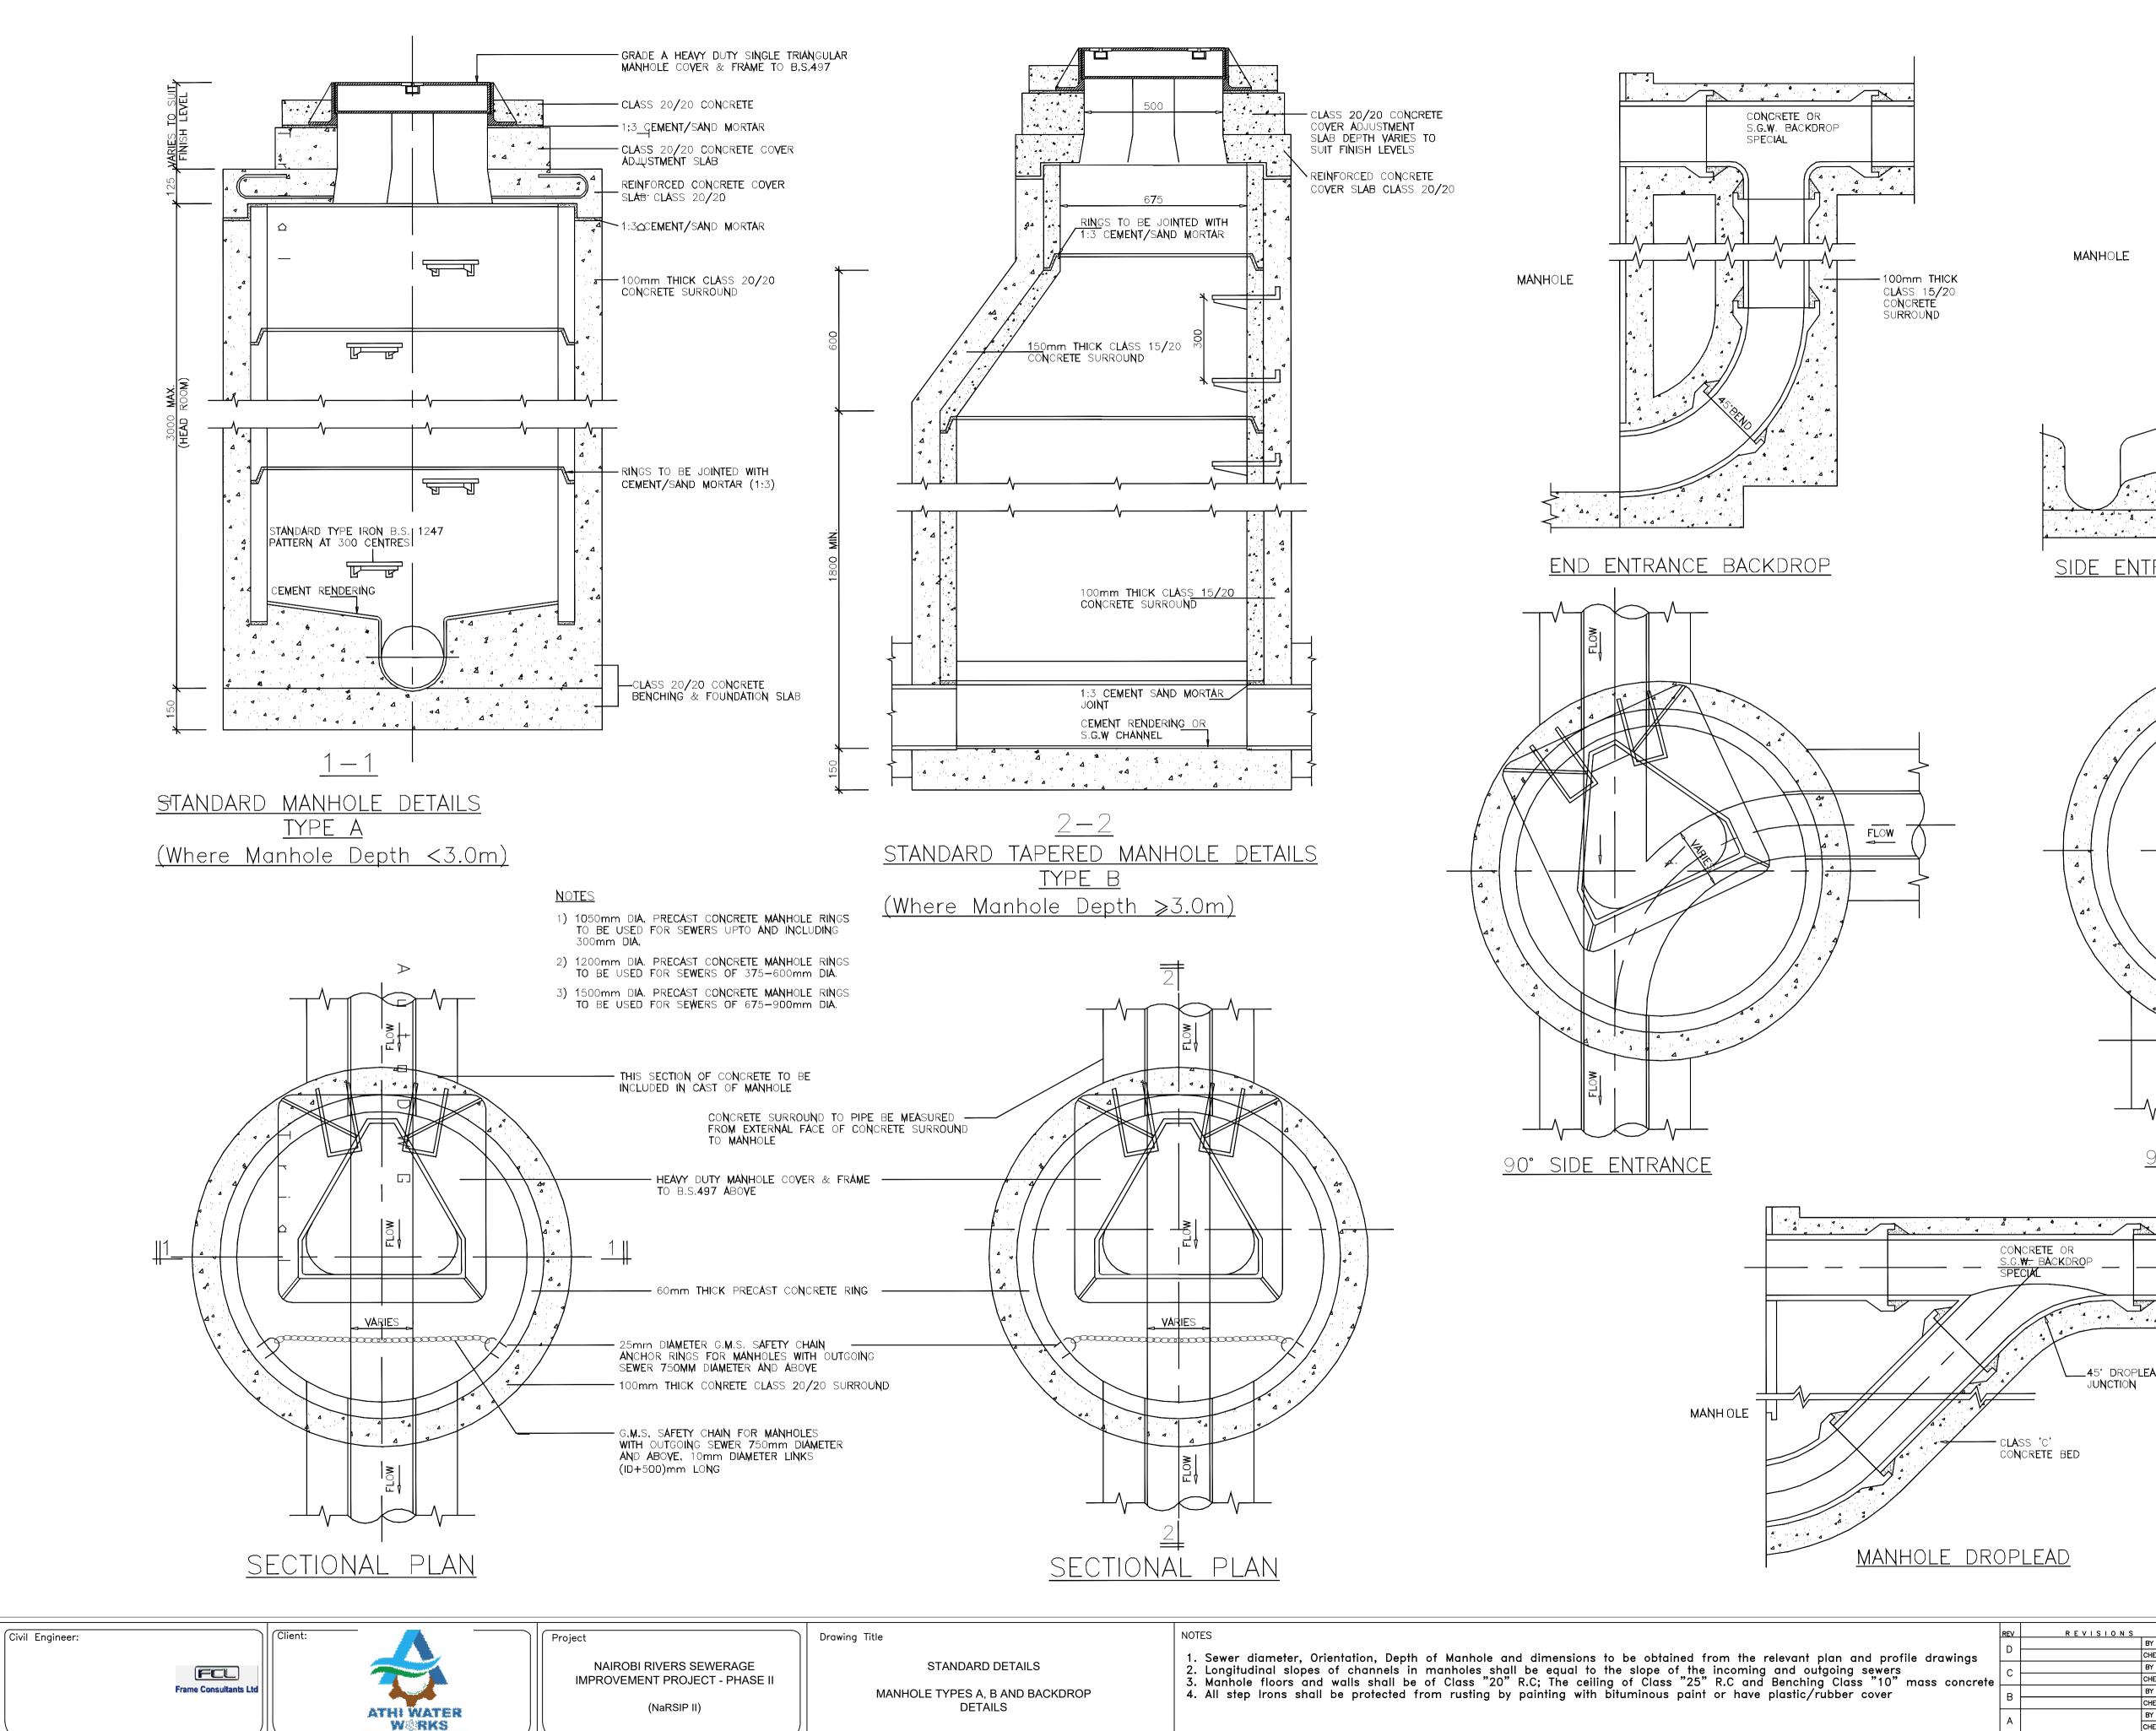

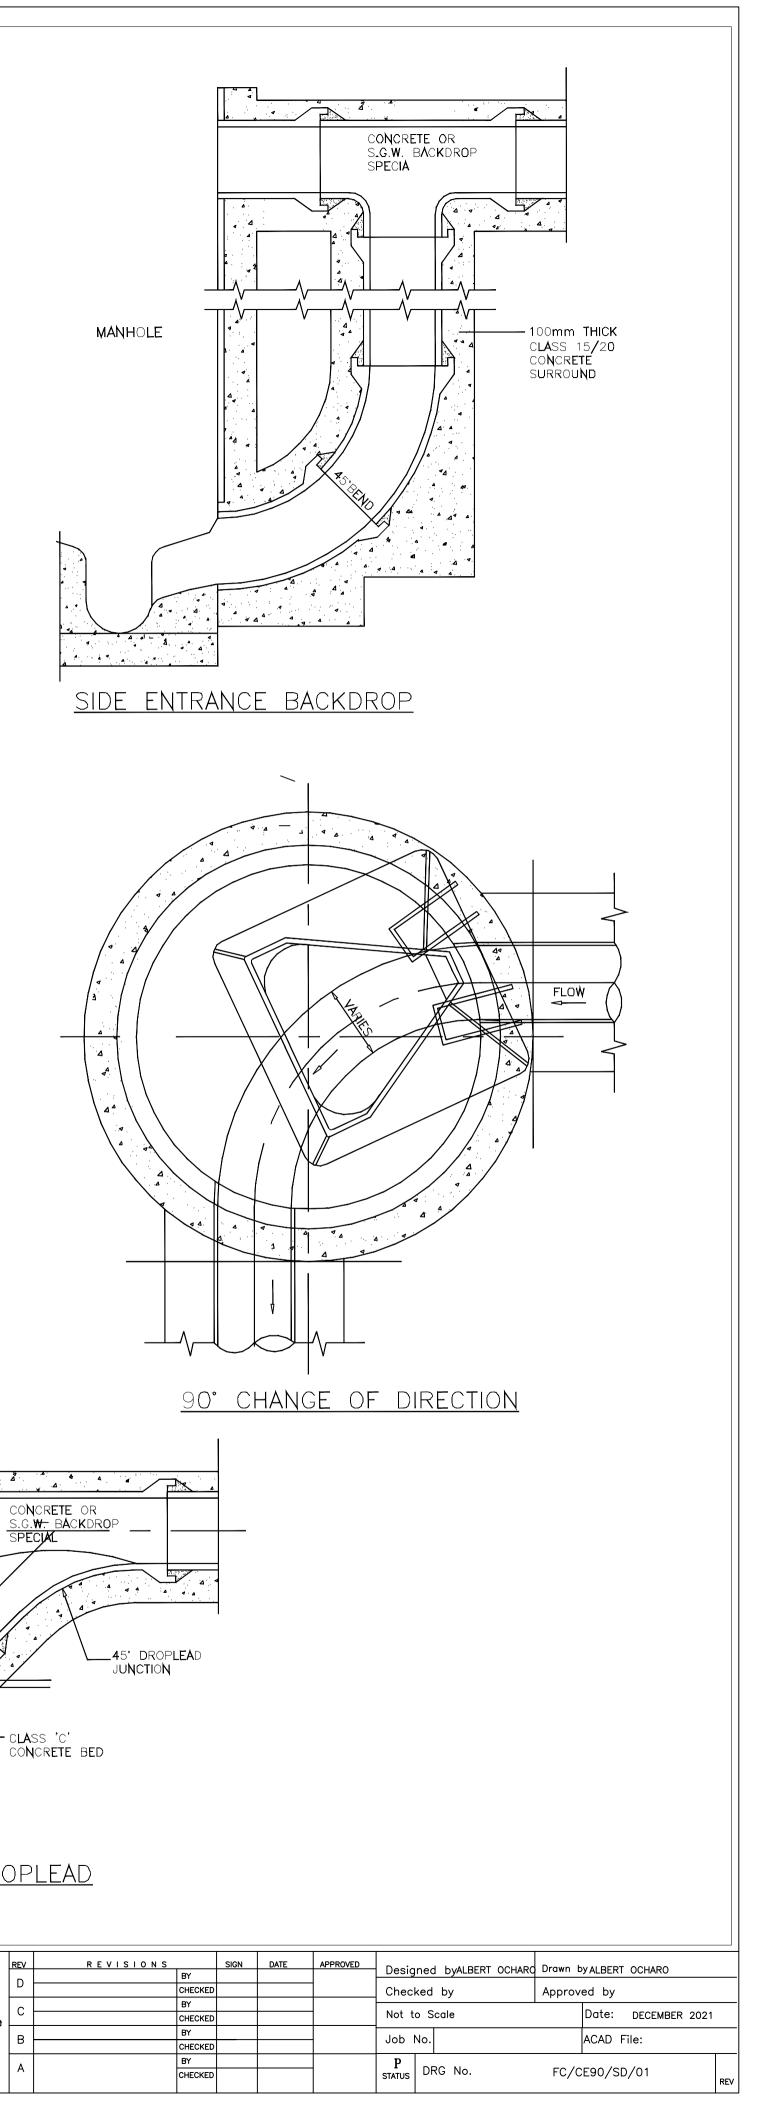

DETAILS OF CHAMBERS

Sewer diameter, Orientation, Depth of Manhole and dimensions to be obtained from the relevant plan and profile drawings
 Longitudinal slopes of channels in manholes shall be equal to the slope of the incoming and outgoing sewers
 Manhole floors and walls shall be of Class "20" R.C; The ceiling of Class "25" R.C and Benching Class "10" mass concret
 All step irons shall be protected from rusting by painting with bituminous paint or have plastic/rubber cover

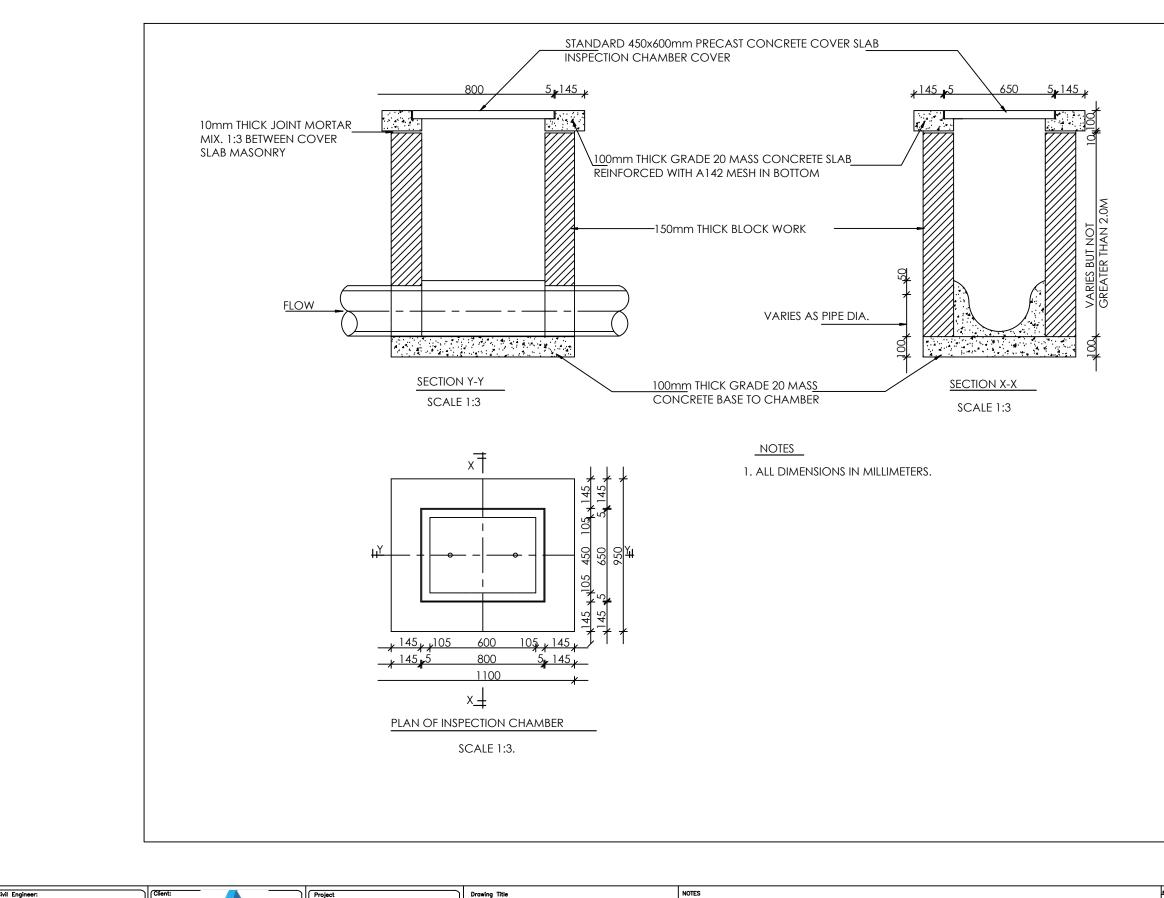

STANDARD DETAILS

MANHOLE COVER, BACKDROP AND CHAMBER DETAILS


NAIROBI RIVERS SEWERAGE IMPROVEMENT PROJECT - PHASE II

(NaRSIP II)

ATHI WATER WORKS

Civil Engineer:

REV	REVISIONS		SIGN	DATE	APPROVED	Deale	ned byALBERT OCHARO	Drawn by		
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NOTES :

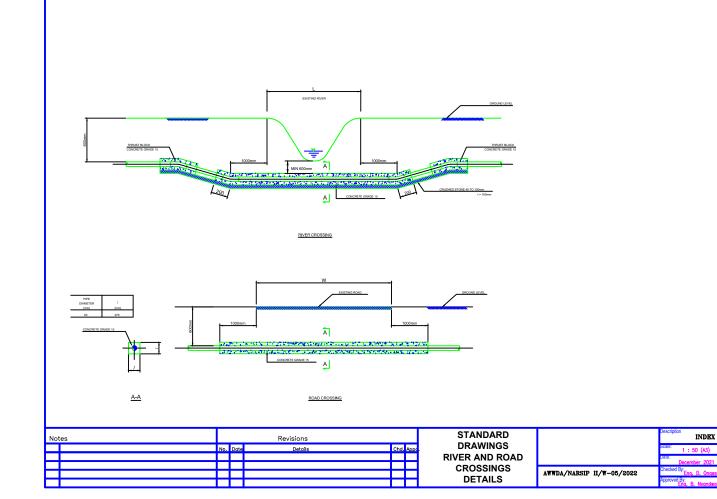- WALLS BUILT OF SOLID CONCRETE BLOCKS OR MASONRY, 150 mm (225 mm) THICK. ALL JOINTS ARE 10 mm THICK.
- 2. EXTERNAL FINISH ON CONCRETE BLOCK WALLS IS 10 mm CEMENT RENDERING WITH TWO COATS EXTERNAL QUALITY WATER PAINT FINISH.
- PLINTH IS 15 mm CEMENT RENDERING WITH BITUMINOUS PAINT FINISH. MINIMUM HEIGHT OF PLINTH ABOVE FINISHED GROUND LEVEL IS 300 mm.
- INTERNAL FINISH ON WALLS IS
 10 mm INTERNAL GAUGED LIME PLASTER WITH GLOSS PAINT FINISH.
- 5. THE PIPES INSIDE THE KIOSK ARE DN 15mm G.I. PIPES.
- 6. WATER METERS ARE INSTALLED INSIDE WATER KIOSK NEAR FENCE.

ATHI WATER

WORKS DEVELOPMENT AGENCY

AWWDA/ACPEU/RRC/01

Albert Ocharo